CARSON CITY ANIMAL SHELTER CARSON CITY, NV

549 AIRPORT ROAD CARSON CITY, NV 89701

February 27, 2015 CONSTRUCTION DOCUMENTS

THIS DESIGN DRAWING IS PROVIDED BY THE DESIGN CONSULTANT. CONSTRUCTION DOCUMENTS TO BE COMPLETED BY THE ARCHITECT OF RECORD AS REQUIRED BY LOCAL AUTHORITIES.

GENERAL NOTES

LEGEND:

- ALL WORK SHALL BE PERFORMED IN ACCORDANCE WITH ALL STATE AND LOCAL BUILDING CODES AND ORDINANCES.
- ALL PUBLIC UTILITY TIE INS TO COMPLY WITH LOCAL MUNICIPALITY REQUIREMENTS.
- CONTRACTOR IS RESPONSIBLE FOR ALL UNDERGROUND UTILITY LOCATIONS AND ASSOCIATED EXCAVATIONS. CONTRACTOR SHALL BECOME FAMILIAR WITH AND EXAMINE THE SITE PRIOR TO PROPOSING OR WORKING ON THE PROJECT. PROPOSING OR WORKING ON THE

PROJECT SHALL CONSTITUTE UNDERSTANDING AND ACCEPTANCE OF ALL

- BRACE PARTITIONS TO ROOF STRUCTURE ABOVE AS REQUIRED.
- ALL EXPOSED WOOD TRIM TO BE STAIN GRADE PINE OR FIR, UNLESS NOTED
- NON-BEARING PARTITIONS MAY BE CONSTRUCTED OF 2x4 WOOD or 3 5/8" 26 GA METAL STUDS AT CONTRACTORS OPTION.
- PARTITIONS DESIGNATED AS DEMISING OR SOUND ATTENUATING SHALL BE CONSTRUCTED AS INDICATED, FROM FLOOR TO STRUCTURE WITH CAULKING AT ENTIRE PERIMETER AND ANY PENETRATIONS TIGHTLY SEALED AND CAULKED. INSULATE ENTIRE CAVITY WITH FULL THICKNESS UNFACED BATT INSULATION.

GENERAL PARTITIONS SHALL EXTEND TO ABOVE FINISH CEILING.

DETAIL CUT SYMBOL

SECTION CUT SYMBOL

ELEVATION SYMBOL

KEYED NOTE SYMBOL

DOOR NUMBER SYMBOL

STANDARD DIMENSION

CLEAR DIMENSION

WINDOW NUMBER SYMBOL

- 10. ALL DOOR FRAMES TO RECEIVE SILENCERS.
- 11. ALL ROOF PENETRATIONS SHALL BE FLASHED BY PROFESSIONAL ROOFER. 12. ALL EXPOSED SURFACES TO BE FINISHED.
- 13. ALL WALL SURFACES TO BE PRIME PAINTED PRIOR TO FINISH COAT OR VWC. 14. ALL TRADES SHALL BE RESPONSIBLE FOR WORK IN THEIR RESPECTIVE TRADES REGARDLESS OF WHERE REFERENCES APPEAR. SHOULD ELECTRICAL WORK APPEAR ON AN ARCHITECTURAL DRAWING, THE ELECTRICAL CONTRACTOR WILL BE HELD RESPONSIBLE FOR ITS COMPLETION: ETC. ALL CONTRACTORS SHOULD BE THOROUGHLY FAMILIAR WITH ALL PLANS AND SPECIFICATIONS SECTIONS AND THE WORK OF ALL OTHER TRADES TO ASSURE COMPLETE COVERAGE AND SYSTEM INTERFACE
- 15. THE CONTRACTOR SHALL SECURE AND PAY FOR ALL BUILDING PERMITS. A BUILDING PERMIT IS REQUIRED. ALL WORK SHALL BE EXECUTED IN ACCORDANCE WITH THE LOCAL AND STATE CODES, ORDINANCES, AND REGULATIONS. GOVERNING THE PARTICULAR CLASS OF WORK INVOLVED. THE BUILDER IS RESPONSIBLE FOR ALL PLAN CHECK AND PERMIT SUBMITTALS, INCLUDING ENERGY CODE COMPLIANCE. THE ARCHITECT WILL FURNISH ALL MECH. AND ELECTRICAL CALCS FOR THE CONTRACTORS USE. THE CONTRACTOR SHALL BE RESPONSIBLE FOR THE FINAL EXECUTION OF THE WORK TO SUIT THESE REQUIREMENTS. ON COMPLETION OF THE WORK, THE CONTRACTOR SHALL OBTAIN AND DELIVER TO THE OWNER, FINAL CERTIFICATES OF ACCEPTANCE AND OCCUPANCY.

ABBREVIATIONS:

ABOVE FINISH FLOOR

ACOUSTICAL CEILING TILE

CUBIC FOOT PER MINUTE

CONCRETE MASONRY UNIT

ALTERNATE

CONTROL JOINT

CENTERLINE

CLEAN OUT

CONTINUOUS

COLD WATER

DIAMETER

EACH WAY

EYEWASH

EXTERIOR

FLOOR DRAIN

FINISH FLOOR

FINISH FLOOR

GYPSUM BOARD

DROP CORD OUTLET

DRINKING FOUNTAIN

DRAIN WASTE VENT

EXPANSION JOINT

ELECTRIC WATER COOLER

CABINET

CEILING

CLEAR

CFM

CLR

CO

CONT

DTL

EA WAY

FIN FLR

EWC

AND STANDARDS BY NEMA, FOR ELECTRICAL COMPONENTS OF GENERAL WORK. PROVIDE UL LISTED AND LABELED PRODUCTS.

GROSS SQUARE FOOT

HOLLOW CORE or HANDICAPPED

HEATING VENTILATING AIR CONDITIONING

OWNER FURNISHED/CONTRACTOR INSTALLED

OWNER FURNISHED/OWNER INSTALLED

GYPSUM BOARD

HOLLOW METAL

HOT WATER

INTERIOR

JANITOR

MAXIMUM

MANHOLE

MINIMUM

OXYGEN

ON CENTER

OCCUPANTS

MECHANICAL

MANUFACTURER

MASONRY OPENING

METAL THRESHOLD

OUTSIDE DIAMETER

OPERATING ROOM

PLASTIC LAMINATE

OVER HEAD or OVERHANG

PAINTED GYPSUM BOARD

NOT IN CONTRACT

NOT TO SCALE

HEIGHT

HVAC

MAX

OCP

OFOI

PCF

PGB

16. EXCEPT AS OTHERWISE INDICATED, COMPLY WITH APPLICABLE PROVISIONS OF NEC

VICINITY MAP

PROPERTY LINE

ROOD DRAIN

REFER

SHEET

SIMILAR

SQUARE

SIM

TOA

TOC

TOW

PER LINEAR FOOT

ROUGH OPENING

SPECIFICATION

SANITARY SEWER

STAINLESS STEEL

TOP OF ASPHALT

TOP OF PARAPET

UNDERGROUND

VENT THRU ROOF

TOP OF WALL

TYPICAL

TOP OF CURB/CONCRETE

UNLESS NOTED OTHERWISE

WATER PROOF/WEATHER PROOF

VIEW BOX ILLUMINATOR

WELDED WIRE FABRIC

POUNDS PER SQUARE FOOT

POUNDS PER SQUARE INCH

SOLID CORE or SEALED CONCRETE

SITE

INDEX TO DRAWINGS

ARCHITECTURAL SITE PLAN

DEMOLITION & EXISTING SITE PLAN

GRADING AND DRAINAGE PLAN

FRONTAGE IMPROVEMENTS PLAN

PLANTING AND IRRIGATION NOTES

SPECIAL INSPECTION NOTES & TABLES CONCRETE GENERAL NOTES & DETAILS

MASONRY GENERAL NOTES & DETAILS

FOUNDATION CONTROL JOINT PLAN

CONCRETE SLAB ON GRADE REQUIREMENTS

EGRESS PLAN

CIVIL SITE PLAN

DETAILS DETAILS

DETAILED UTILITY PLAN

LANDSCAPE DETAILS MULCHING PLAN

TIMBER GENERAL DETAILS

ROOF FRAMING PLAN

FOUNDATION DETAILS

DIMENSION PLAN

ROOF PLAN

ARCHITECTURAL FLOOR PLAN

REFLECTED CEILING PLAN

EXTERIOR ELEVATIONS

INTERIOR ELEVATIONS

2012 INTERNATIONAL BUILDING CODE

2012 INTERNATIONAL FUEL GAS CODE

2012 UNIFORM MECHANICAL CODE

2012 UNIFORM PLUMBING CODE

2012 INTERNATIONAL MECHANICAL CODE

WALL SECTIONS WALL SECTIONS

CODES

IRRIGATION PLAN **IRRIGATION DETAILS**

		BDA DESIGN REVIEW BDA TECHNICAL REVIEW
=		REVISIONS:
REV. NO.	DATE	COMMENTS

WALL SECTIONS

SOFFIT DETAILS

WINDOW DETAILS

DOOR DETAILS DOOR DETAILS

MISCELLANEOUS DETAILS MISCELLANEOUS DETAILS

ROOF AND WALL DETAILS

INTERIOR SPECIFICATIONS REFERENCE FLOOR PLAN

PLUMBING MEDICAL GAS PLAN

INTERIOR ELEVATIONS

PLUMBING GAS PLAN

PLUMBING DETAILS

MECHANICAL DETAILS

MECHANICAL DETAILS

LIGHTING PLAN RECEPTACLE PLAN

2011 NATIONAL ELECTRIC CODE

INITIALS

2009 INTERNATIONAL ENERGY CONSERV. CODE

2012 NORTHERN NEVADA AMENDMENTS

2011 NORTHERN NEVADA ENERGY CODE AMEND.

2012 INTERNATIONAL PROPERTY MAINTENANCE CODE


MECHANICAL SCHEDULES

POWER PLAN - MECHANICAL

ELECTRICAL LEGEND, SCHEDULES, DETAILS

ELECTRICAL ROOF PLAN

DOOR SCHEDULE AND TYPES

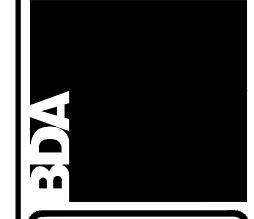



CONSULTANTS

RESOURCE CONCEPTS, IN
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FAX:
E-MAIL: jeff@rci-nv.com

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STRUCTURAL: JJK GROUP, INC. 3240 C JUAN TABO NE ALBUQUERQUE, NM 87111 PHONE: (505) 296-5706

FAX: (505) 296-1672

E-MAIL: jim@jjkgroup.com


E-MAIL: sandra@swlsa.com

ELECTRICAL PLUMBING:

THE RESPONSE GROUP, INC. 11930 MENAUL NE ALBUQUERQUE, NM 87112 PHONE: (505) 323-7629 FAX: (505) 323-7594 E-MAIL: theresponsegroup@trg-inc.net PROJECT DATA:

HOULC	I DAIA.			
GAL DESCRIPTION:	A PORTION OF APN 010-031-04	RELEVANT	CODE:	SEE ABOVE
E ADDRESS:	549 AIRPORT ROAD	BUILDING	TYPE:	ANIMAL SHELTER and CLINIC
L ADDITESS.	CARSON CITY, NEVADA 89701	OCCUPAN	CY TYPE:	В
RRENT ZONING:	PUBLIC REGIONAL (PR)	CONSTRU	CTION TYPE:	VB
E AREA:	1.5 ACRES		LE AREA: 9000 SF x2 SPRINKLED)	18,000 SF
		GROSS US	SABLE AREA (CURRENT): BUILDING: KENNELS & GARAGE: TOTAL:	10,326 SF 7,411 SF 4,136 SF 11,547 SF
		OCCUPAN	T LOAD (CURRENT): 11,547 FF BUSINESS - 1/100:	115
		EXITS:	REQUIRED: CURRENT PROVIDED:	2 5
		WIDTHS:	REQUIRED:	.2 x 104 = 20.8

CURRENT PROVIDED:

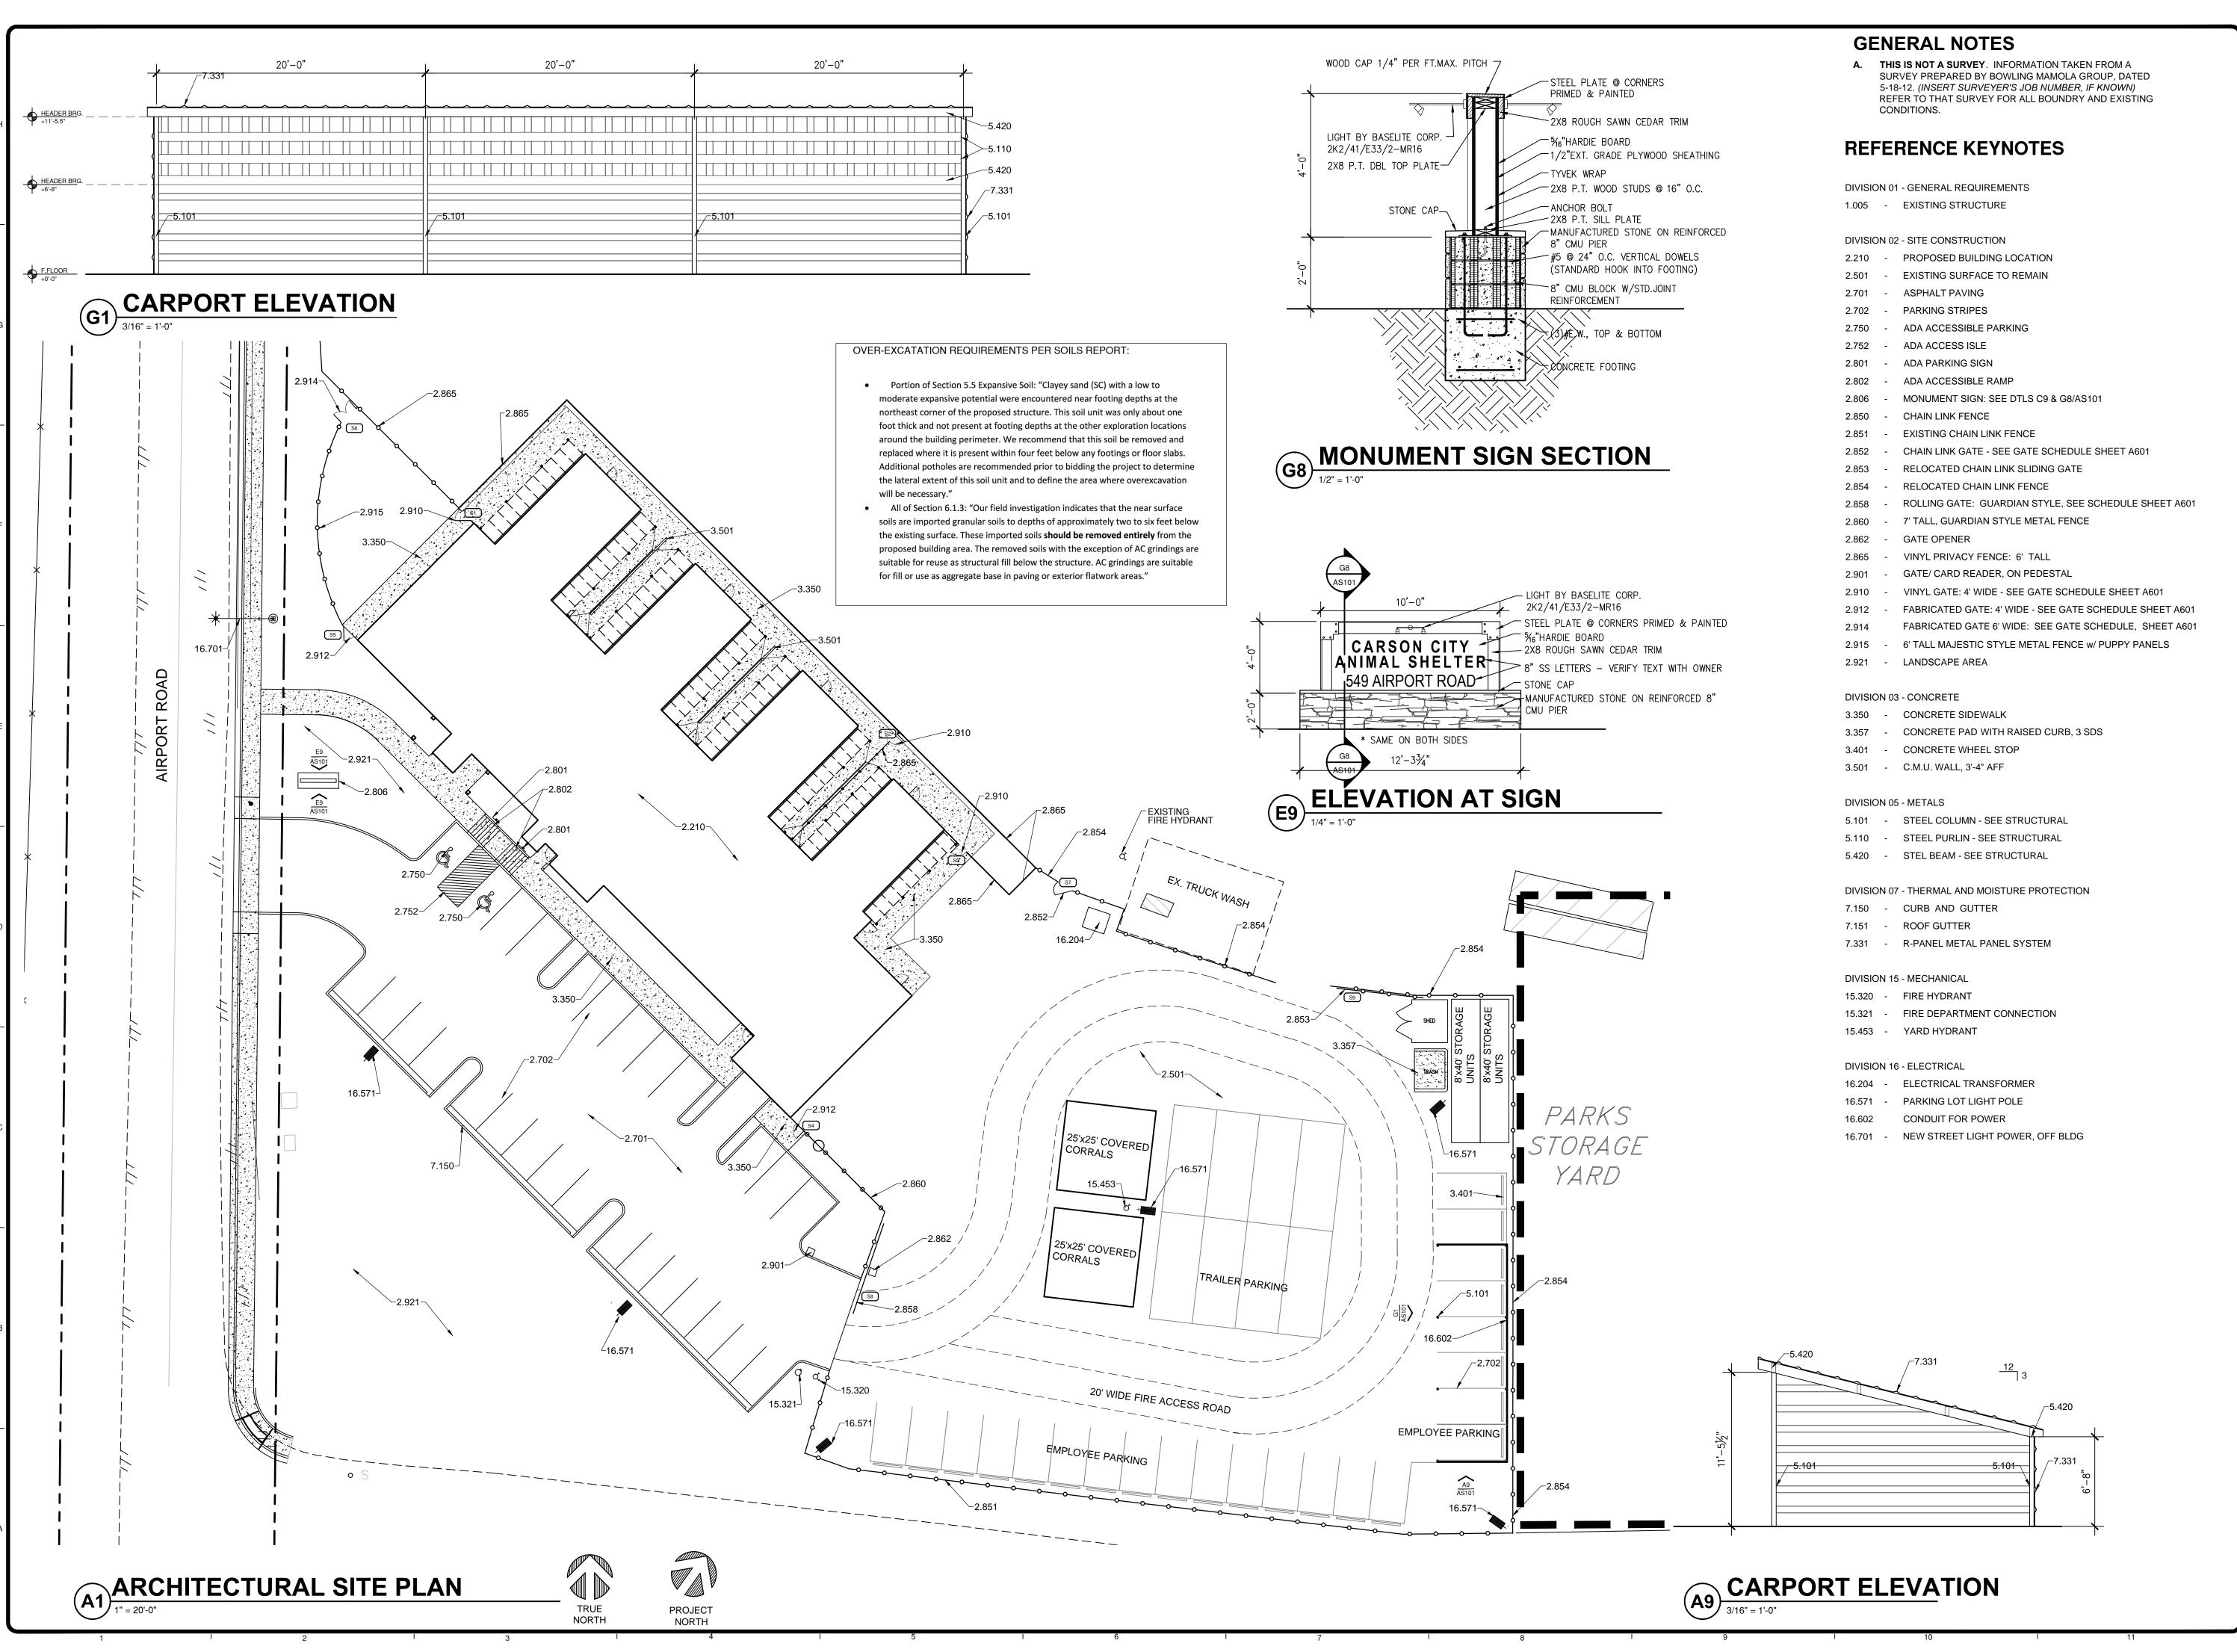


REV.# DATE COMMENTS ISION: - COMMENTS | COMM

REVIEWS
ALS
BDA DSGN. REV.
BDA TECH REV.

2/27/2015

CCAS
PROJECT NO.: 1107
DRAWN: DG

AS10

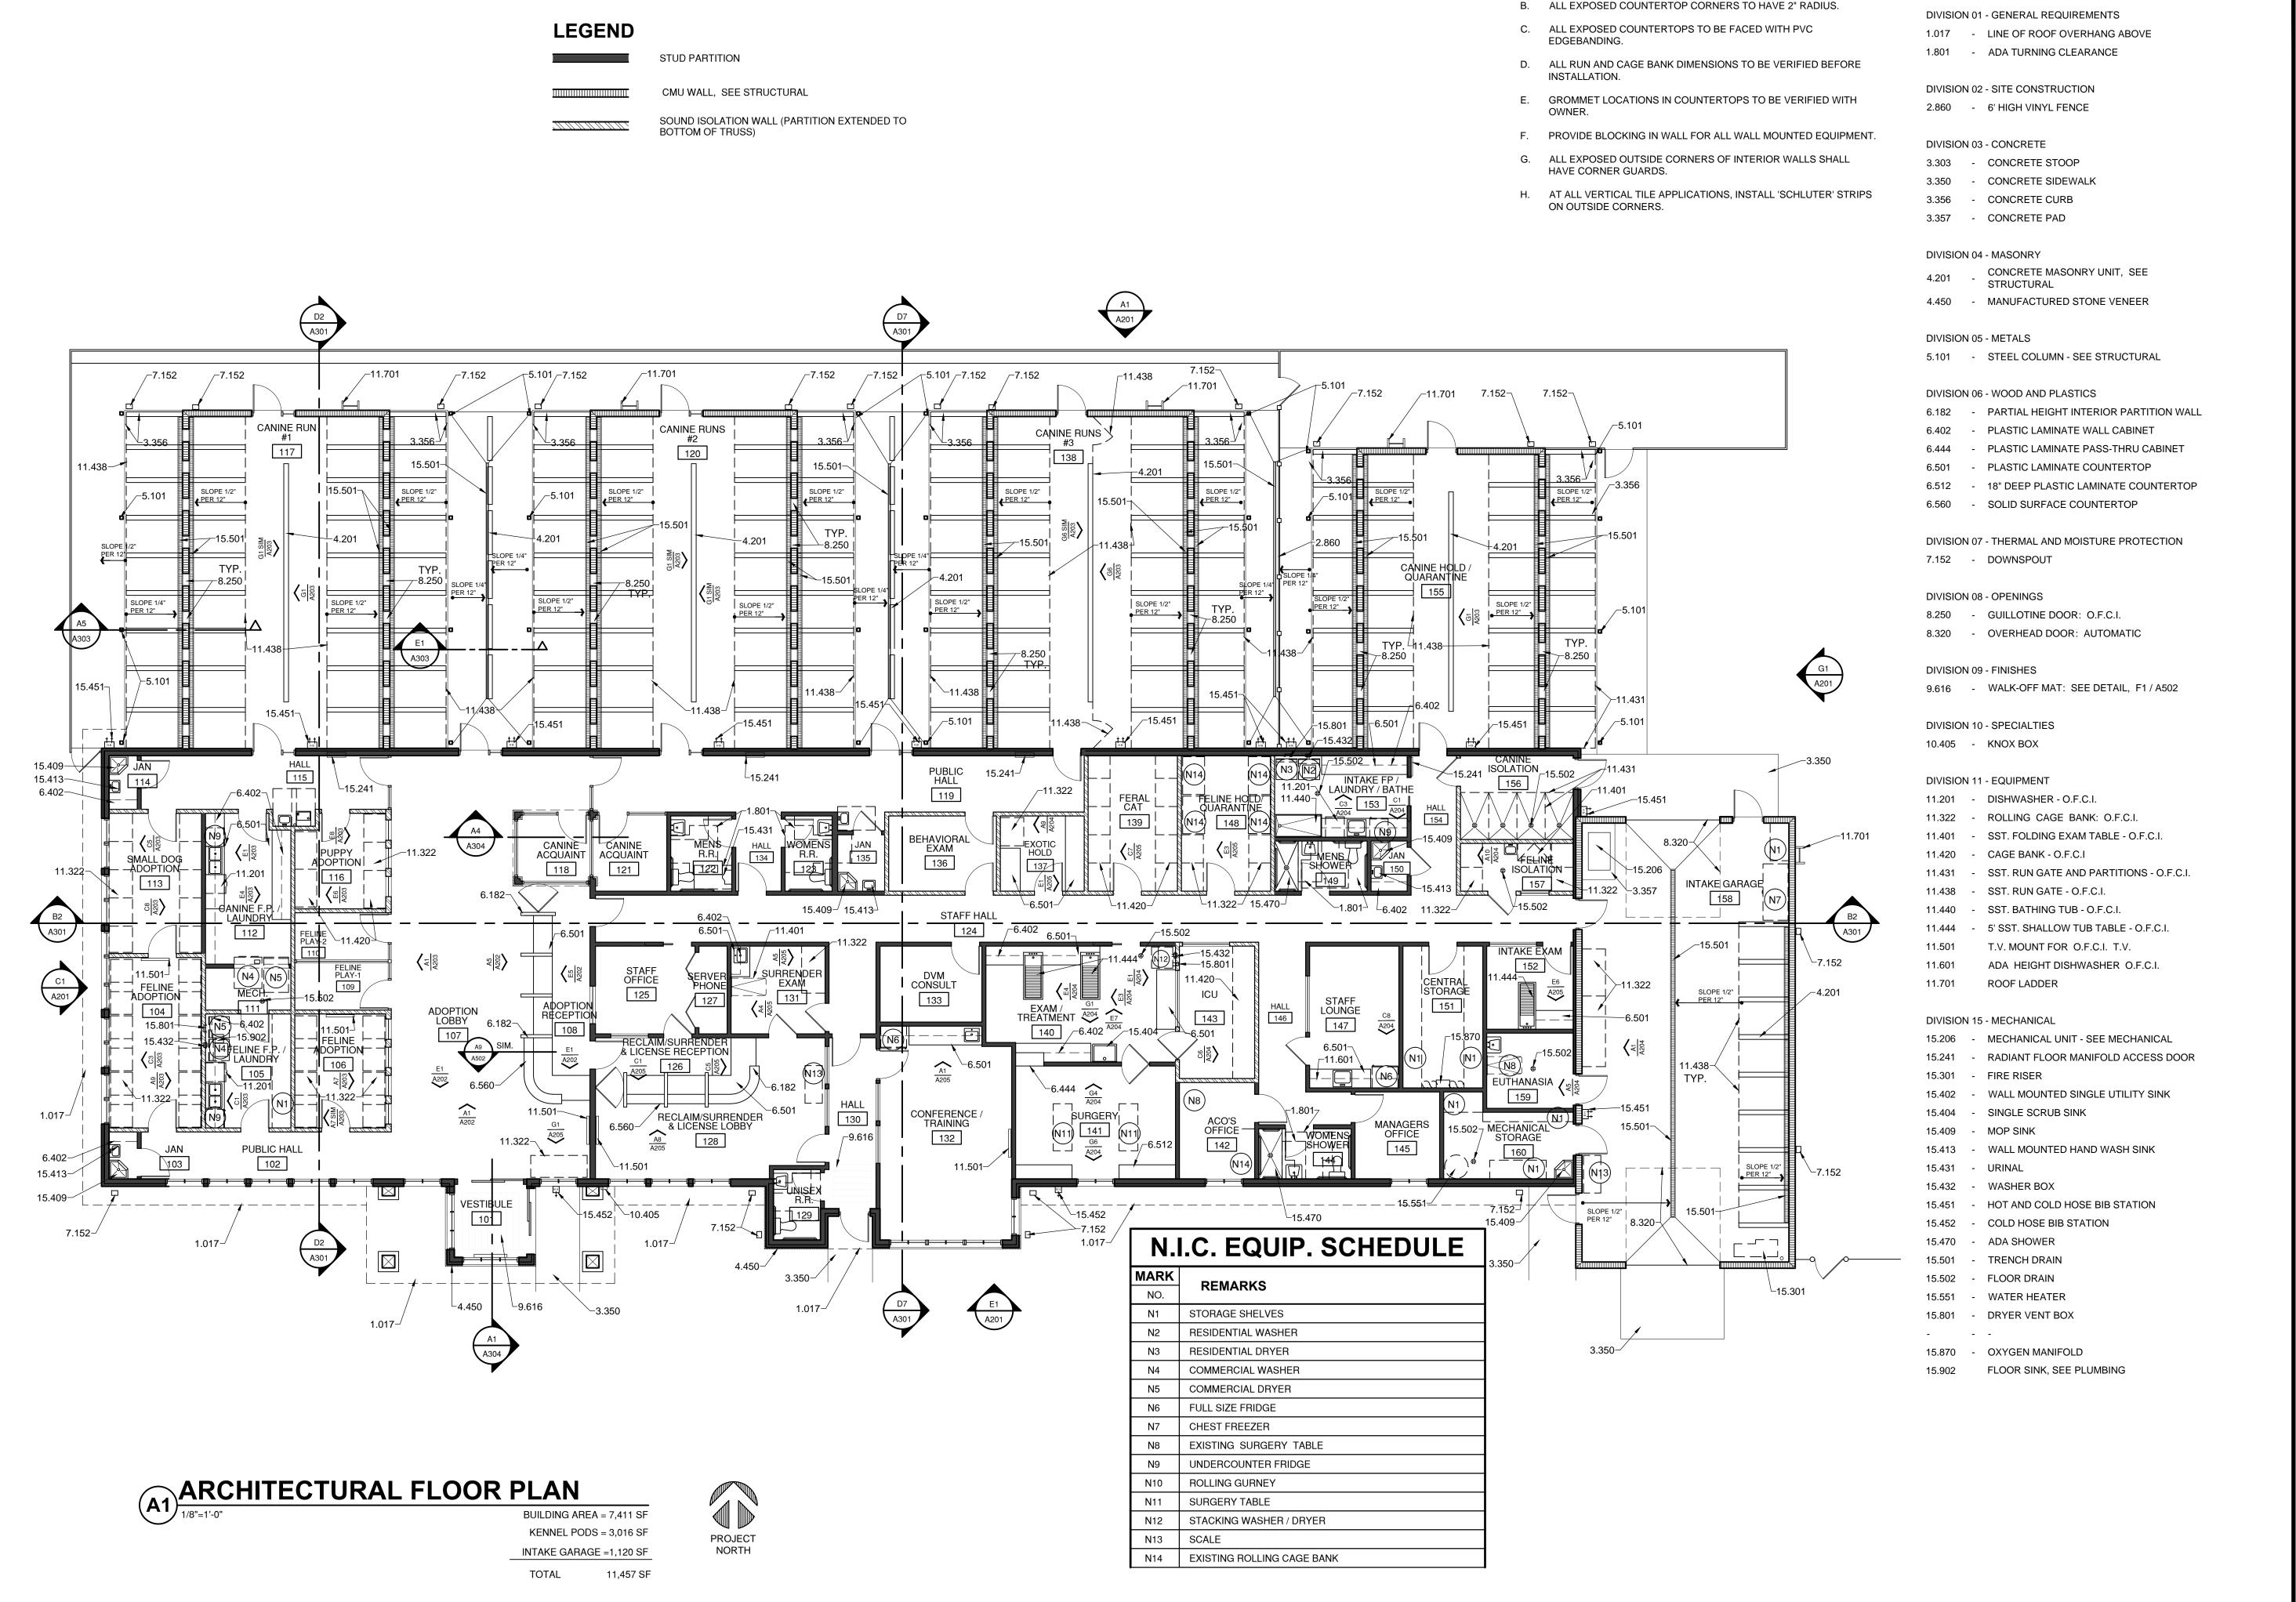

GENERAL NOTES

A. ALL CASEWORK TO HAVE PLASTIC LAMINATE FINISH, U.N.O.

REFERENCE KEYNOTES




RS IAL

BDA DSGN. REV. BDA TECH REV.

PROJECT NO.: 1107 DRAWN: DATE: 2/27/2015

- OF

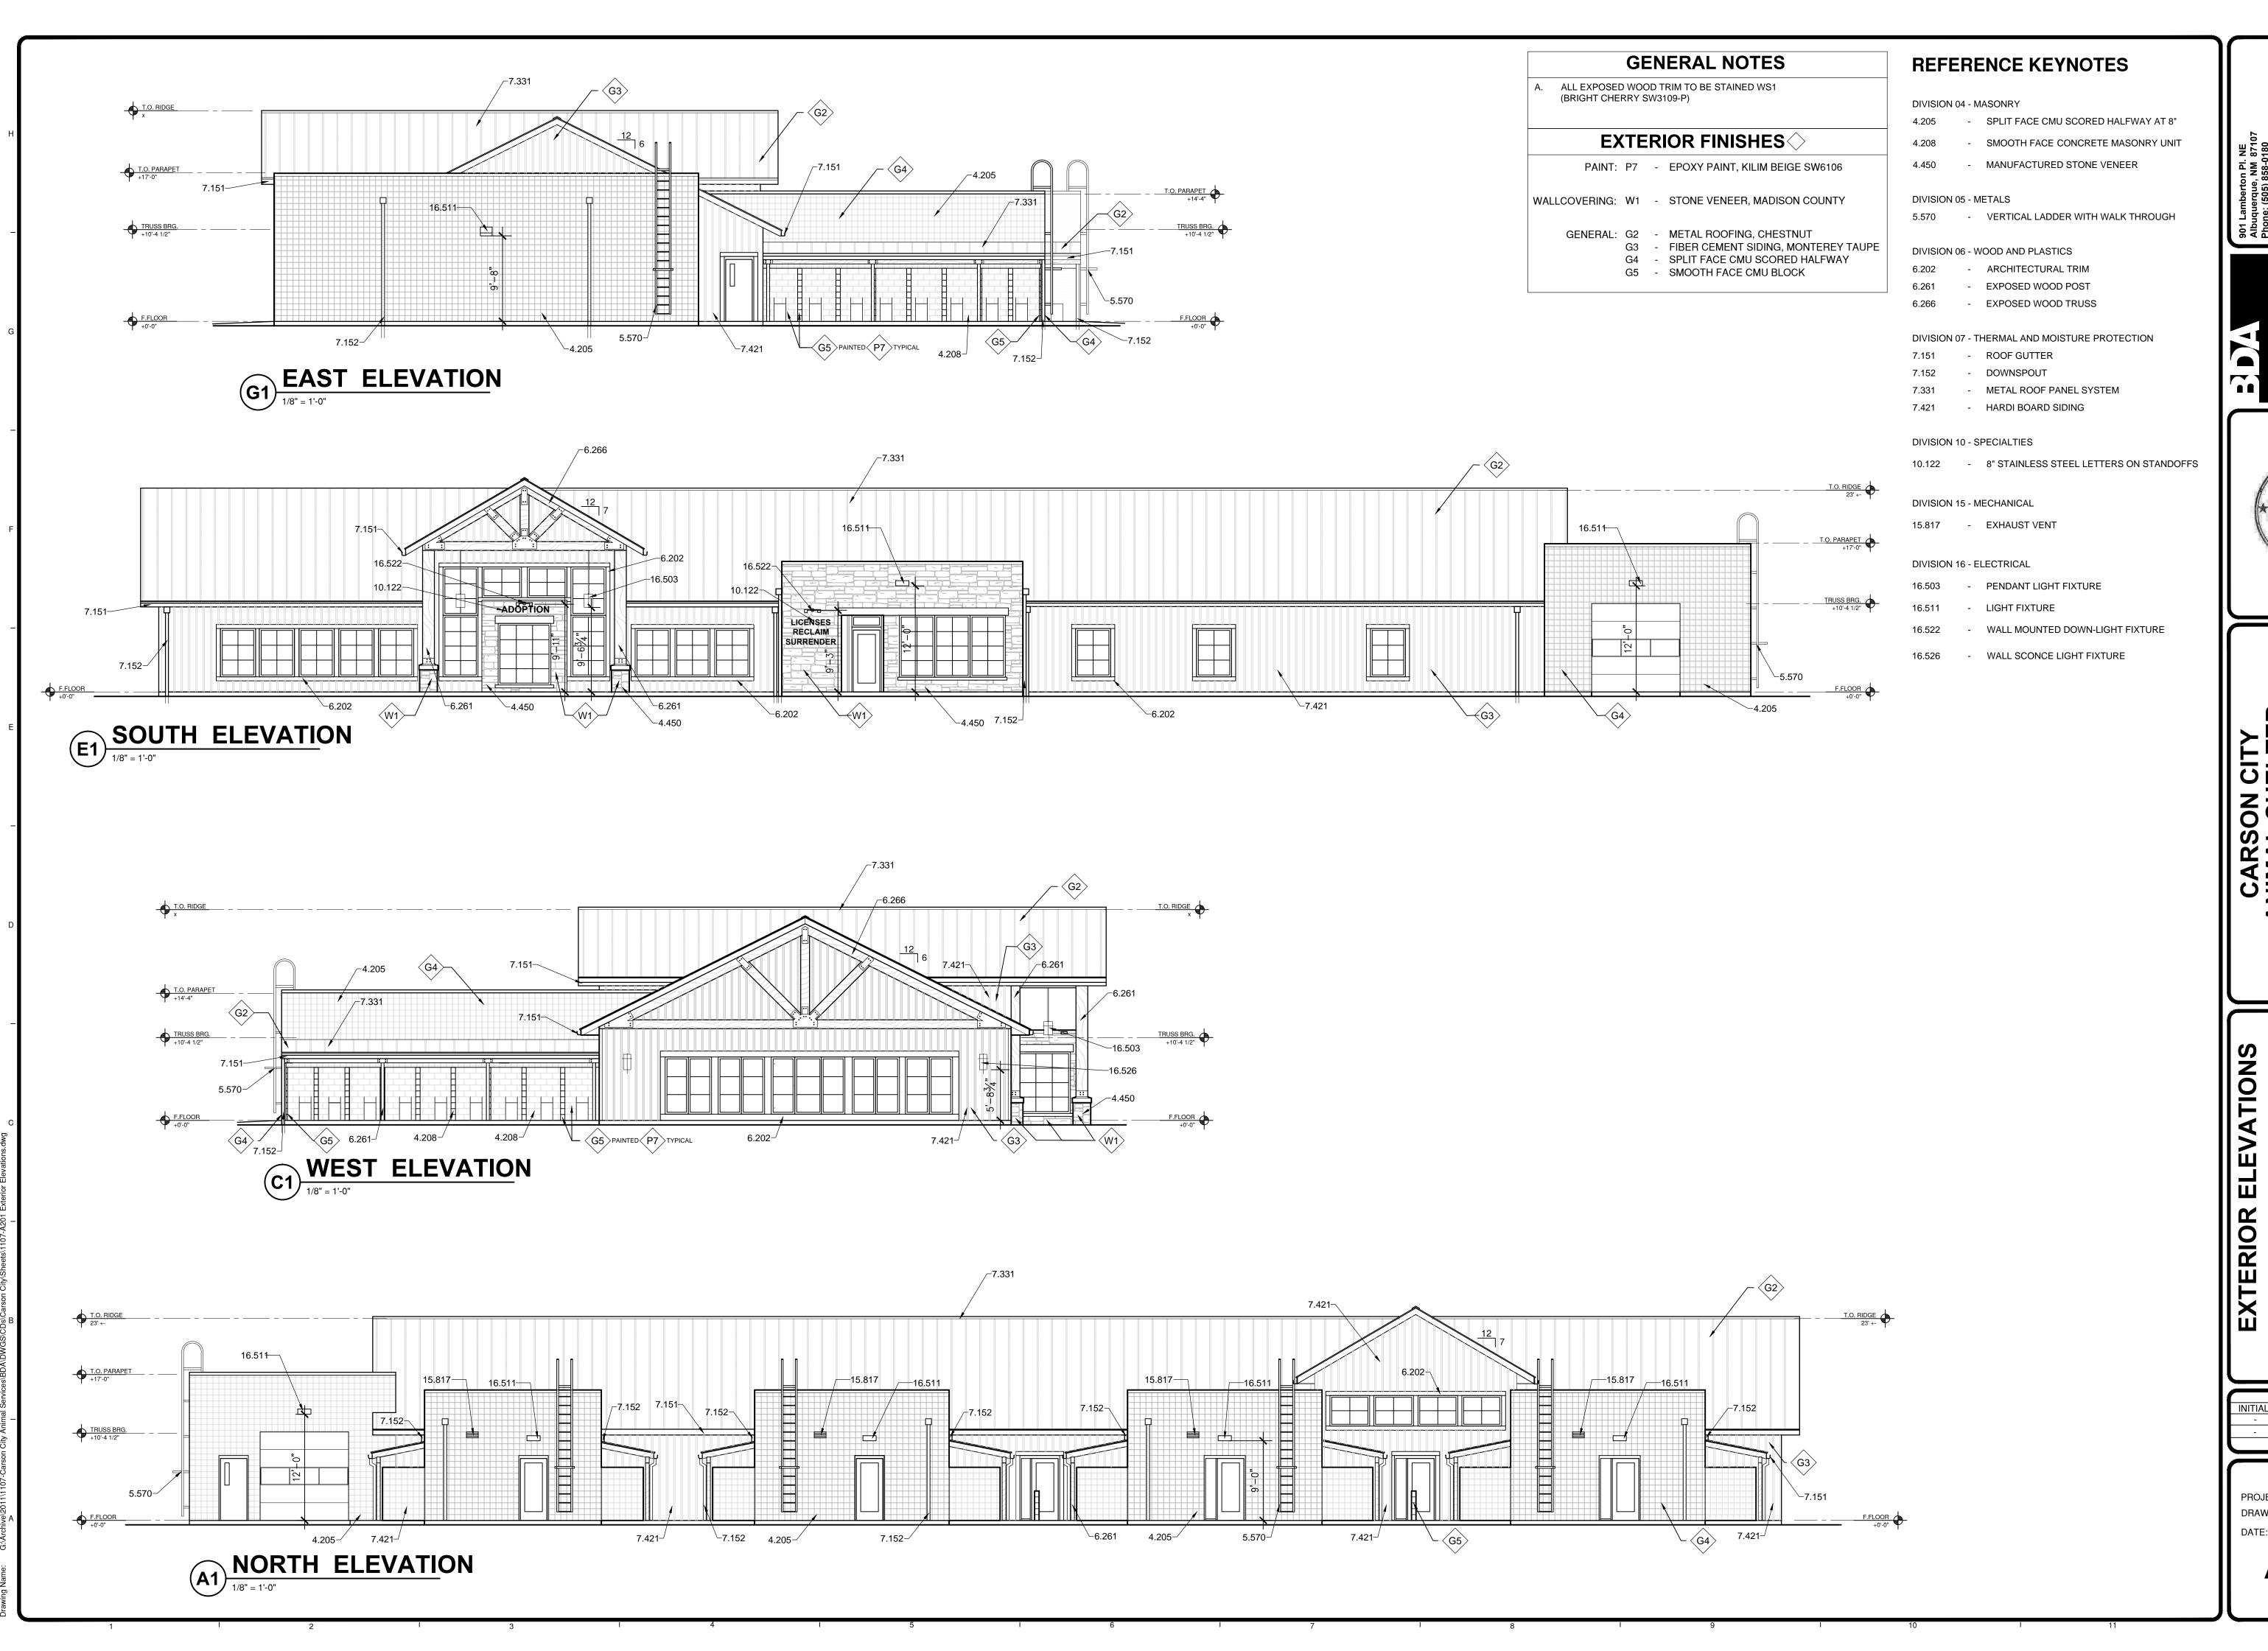



BDA DSGN. REV. BDA TECH REV.

PROJECT NO.: 1107 DATE: 2/27/2015

A201

Carson City Animal Shelter

549 Airport Road Carson City, Nevada 89701

ABBREVIATIONS:

REVIATIONS LISTED BELOW MAY NOT BE INCLUDED IN THIS PLAN SET)

```
ASPHALTIC CONCRETE
AMERICANS WITH DISABILITIES ACT
         FIRE DEPARTMENT CONNECTION
         FINISHED FLOOR
         FIRE HYDRANT
         FLOW LINE
         FEET
         GAS LINE
         GROUND SHOT
         HIGH DENSITY POLYETHYLENE
         HIGH POINT
         MAXIMUM
         MAXIMUM DRY DENSITY
         MINIMUM
         NECESSARY
         OVERHEAD POWER
        PORTLAND CEMENT CONCRETE
POLYETHYLENE
POST INDICATOR VALVE
         POINT ON LINE
         POINT ON CURVE
         POWER POLE
         POINT OF REVERSE CURVE
         POLYVINYL CHLORIDE
         REDUCED PRESSURE BACKFLOW ASSEMBLY
         STORM DRAIN
         STORM DRAIN MANHOLE
SHT
         SANITARY SEWER
         SANITARY SEWER MANHOLE
        TOP BACK OF CURB
         TRENCH DRAIN
         TOP OF PCC BENCH
         TOP OF STEP
         TYPICAL
```


WATER

INCHES PERCENT

WATER VALVE

VALLEY GUTTER

UNDERGROUND POWER

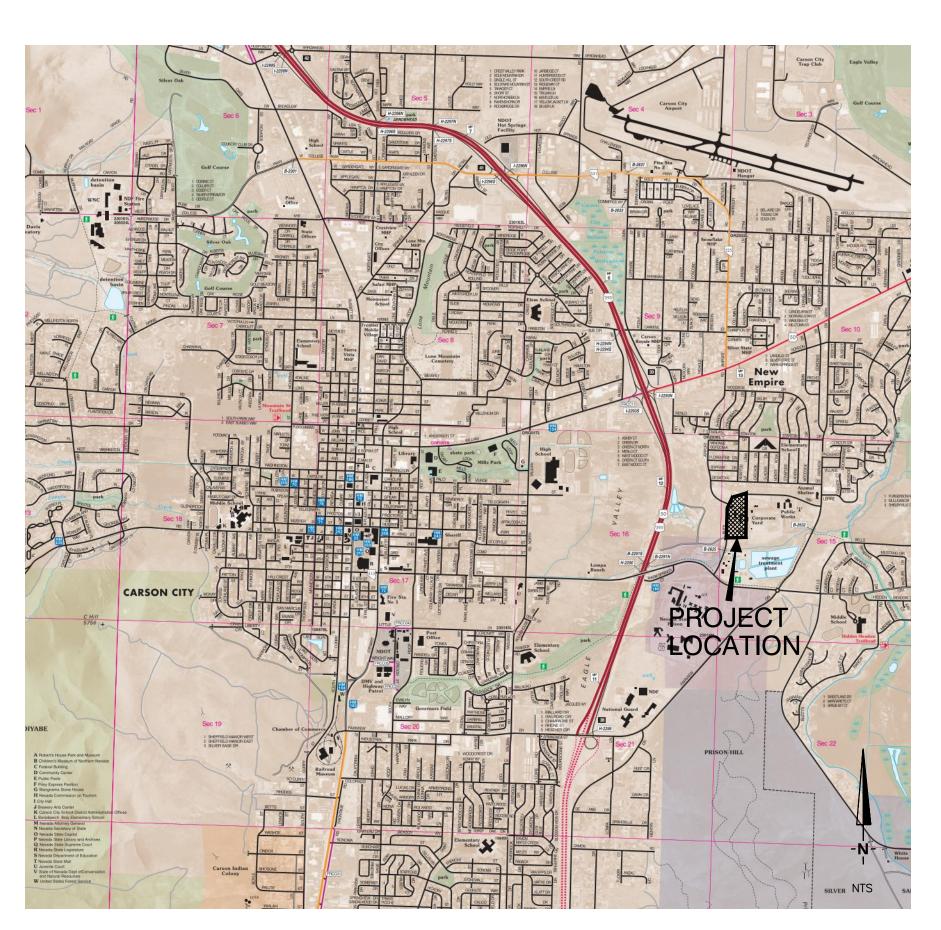

VICINITY MAP

CIVIL SHEET INDEX

Sheet C101 - Cover Sheet

Sheet C102 - Demolition and Existing Site Plan

Sheet C103 - Civil Site Plan

Sheet C104 - Grading and Drainage Plan

Sheet C105 - Overall Utility Plan

Sheet C106 - Detailed Utility Plan


Sheet C107 - Frontage Improvements Plan

Sheet C108 - Details

Sheet C109 - Details

Sheet C110 - Details


Sheet C111 - Details

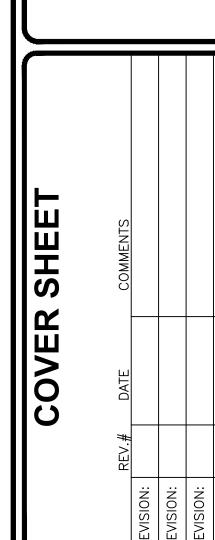


BDA DSGN. REV BDA TECH REV.

PROJECT NO.: 14-227.1C


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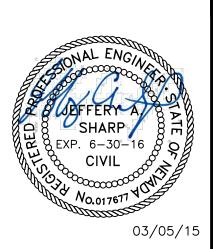


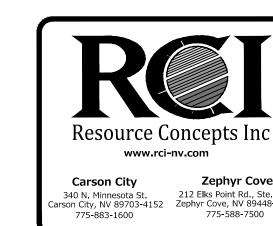




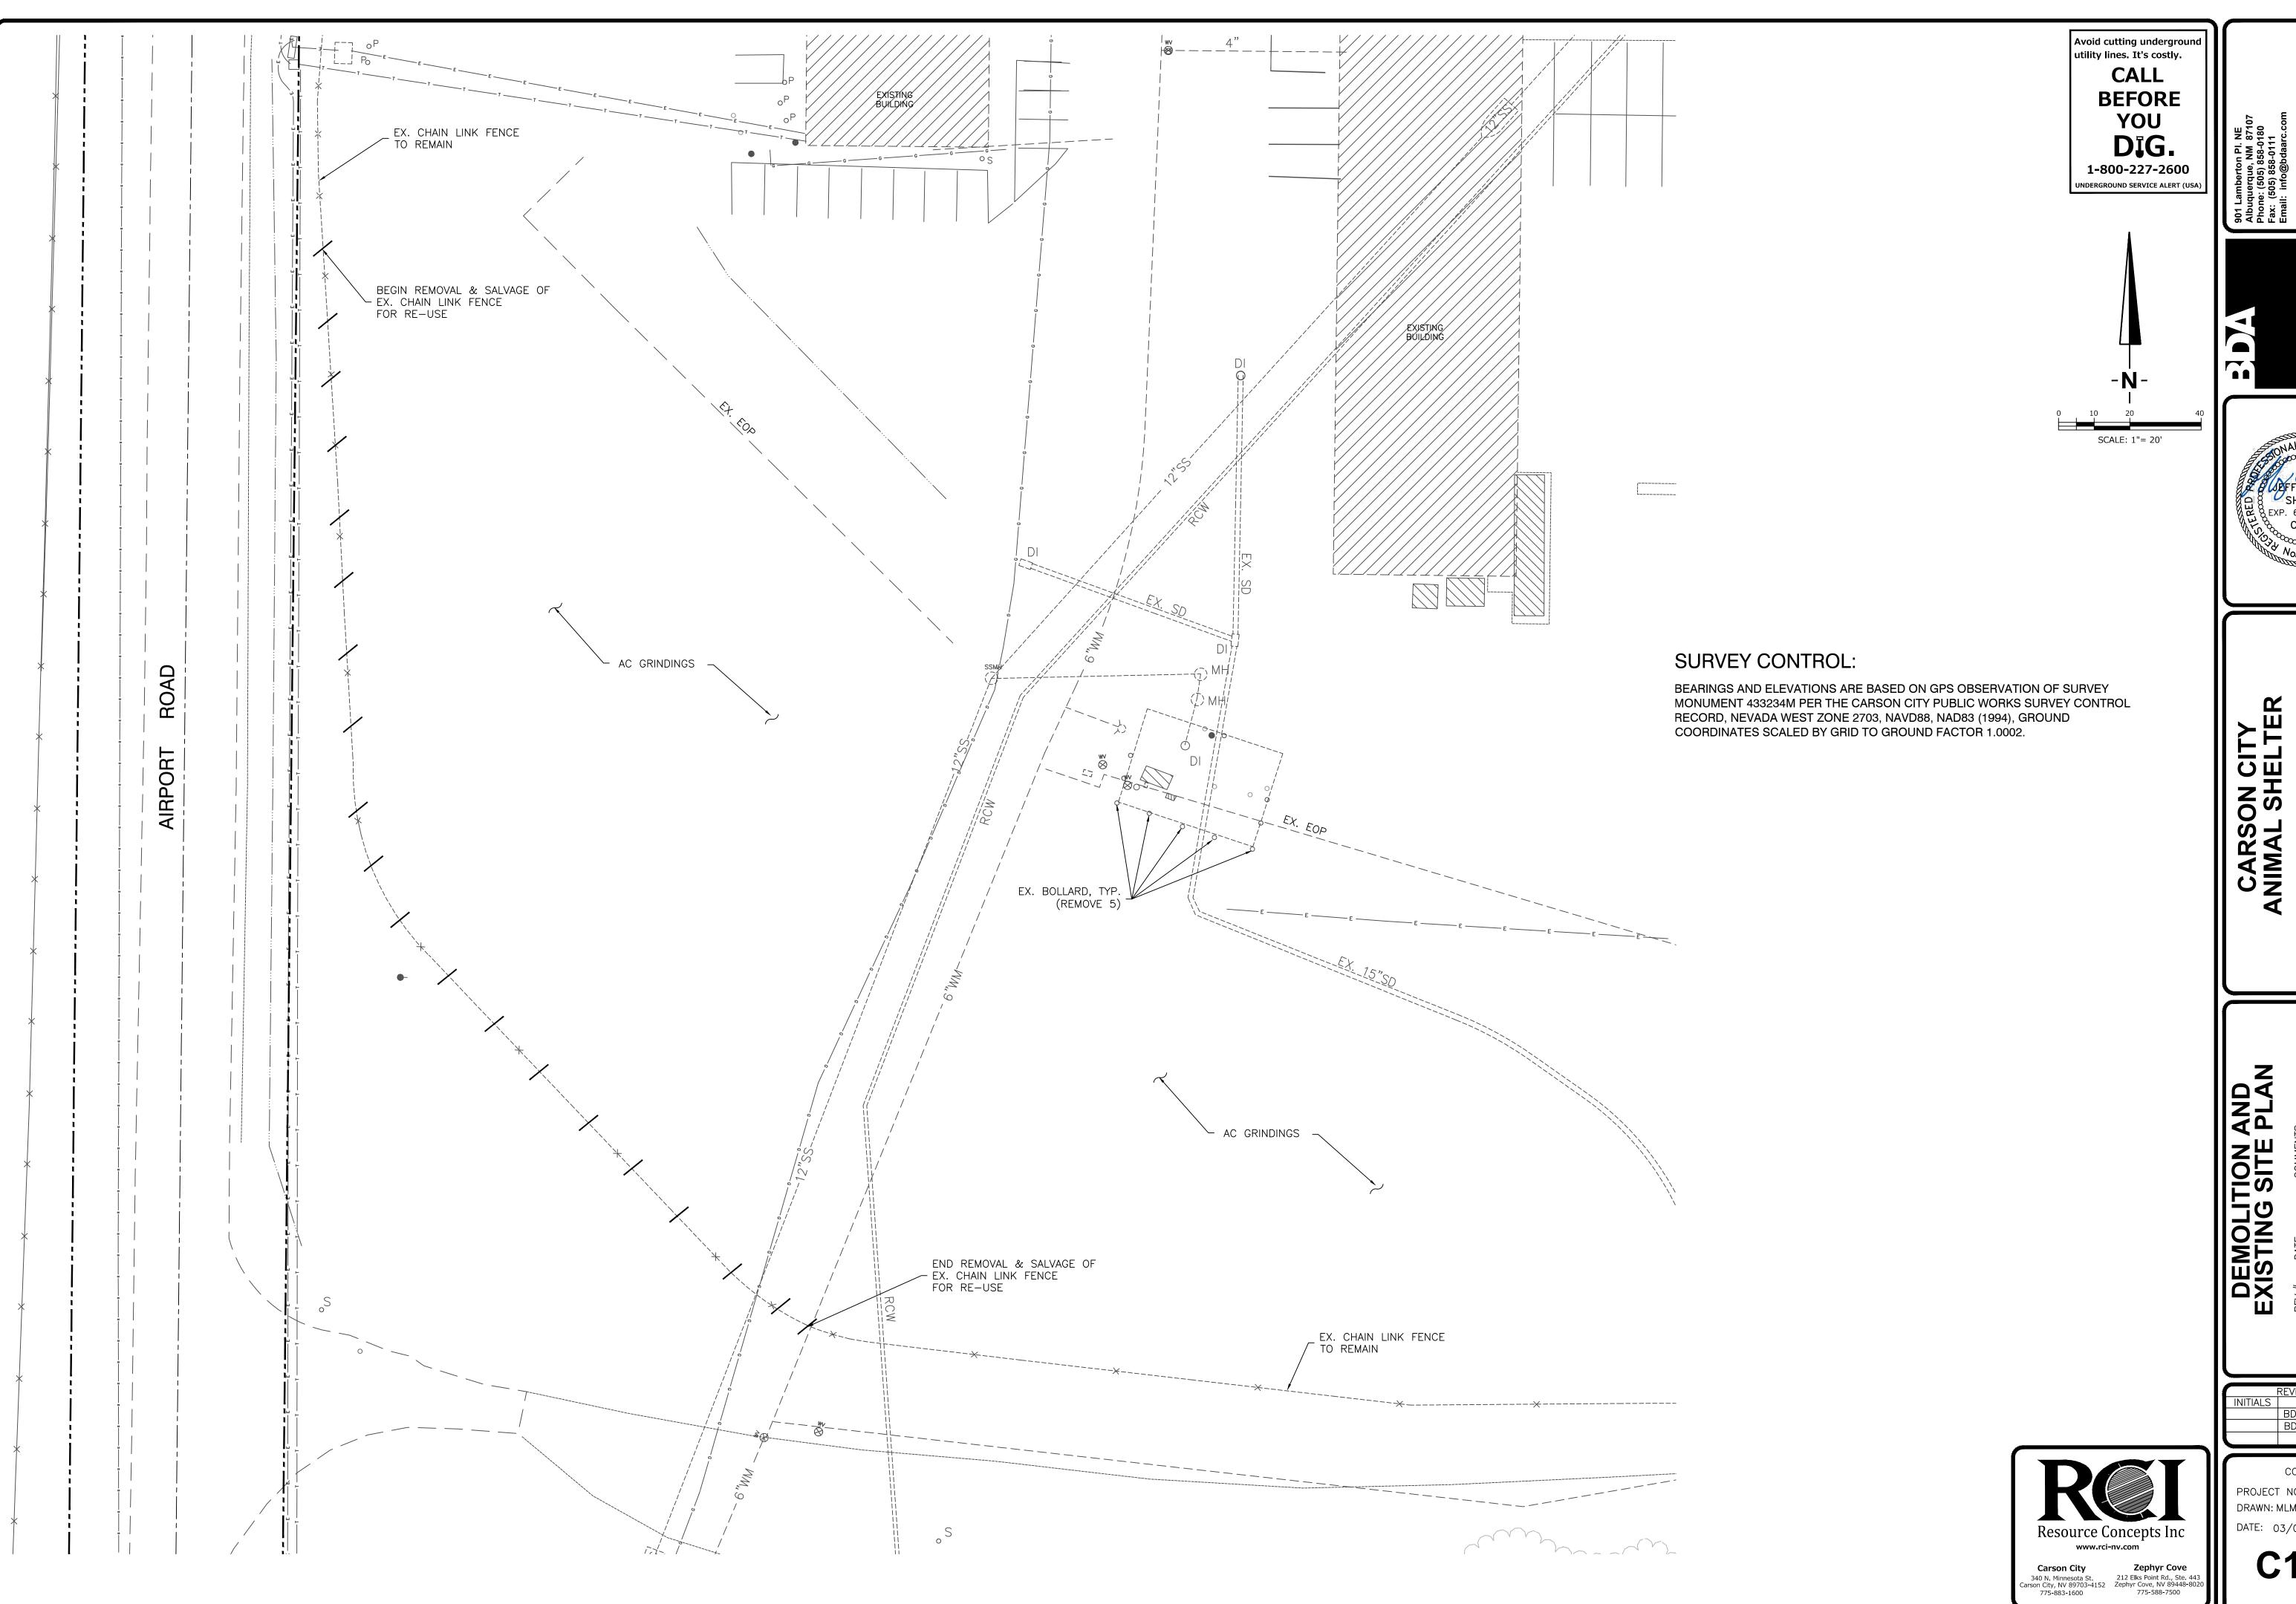





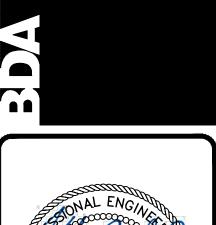

BDA DSGN. REV. BDA TECH REV.

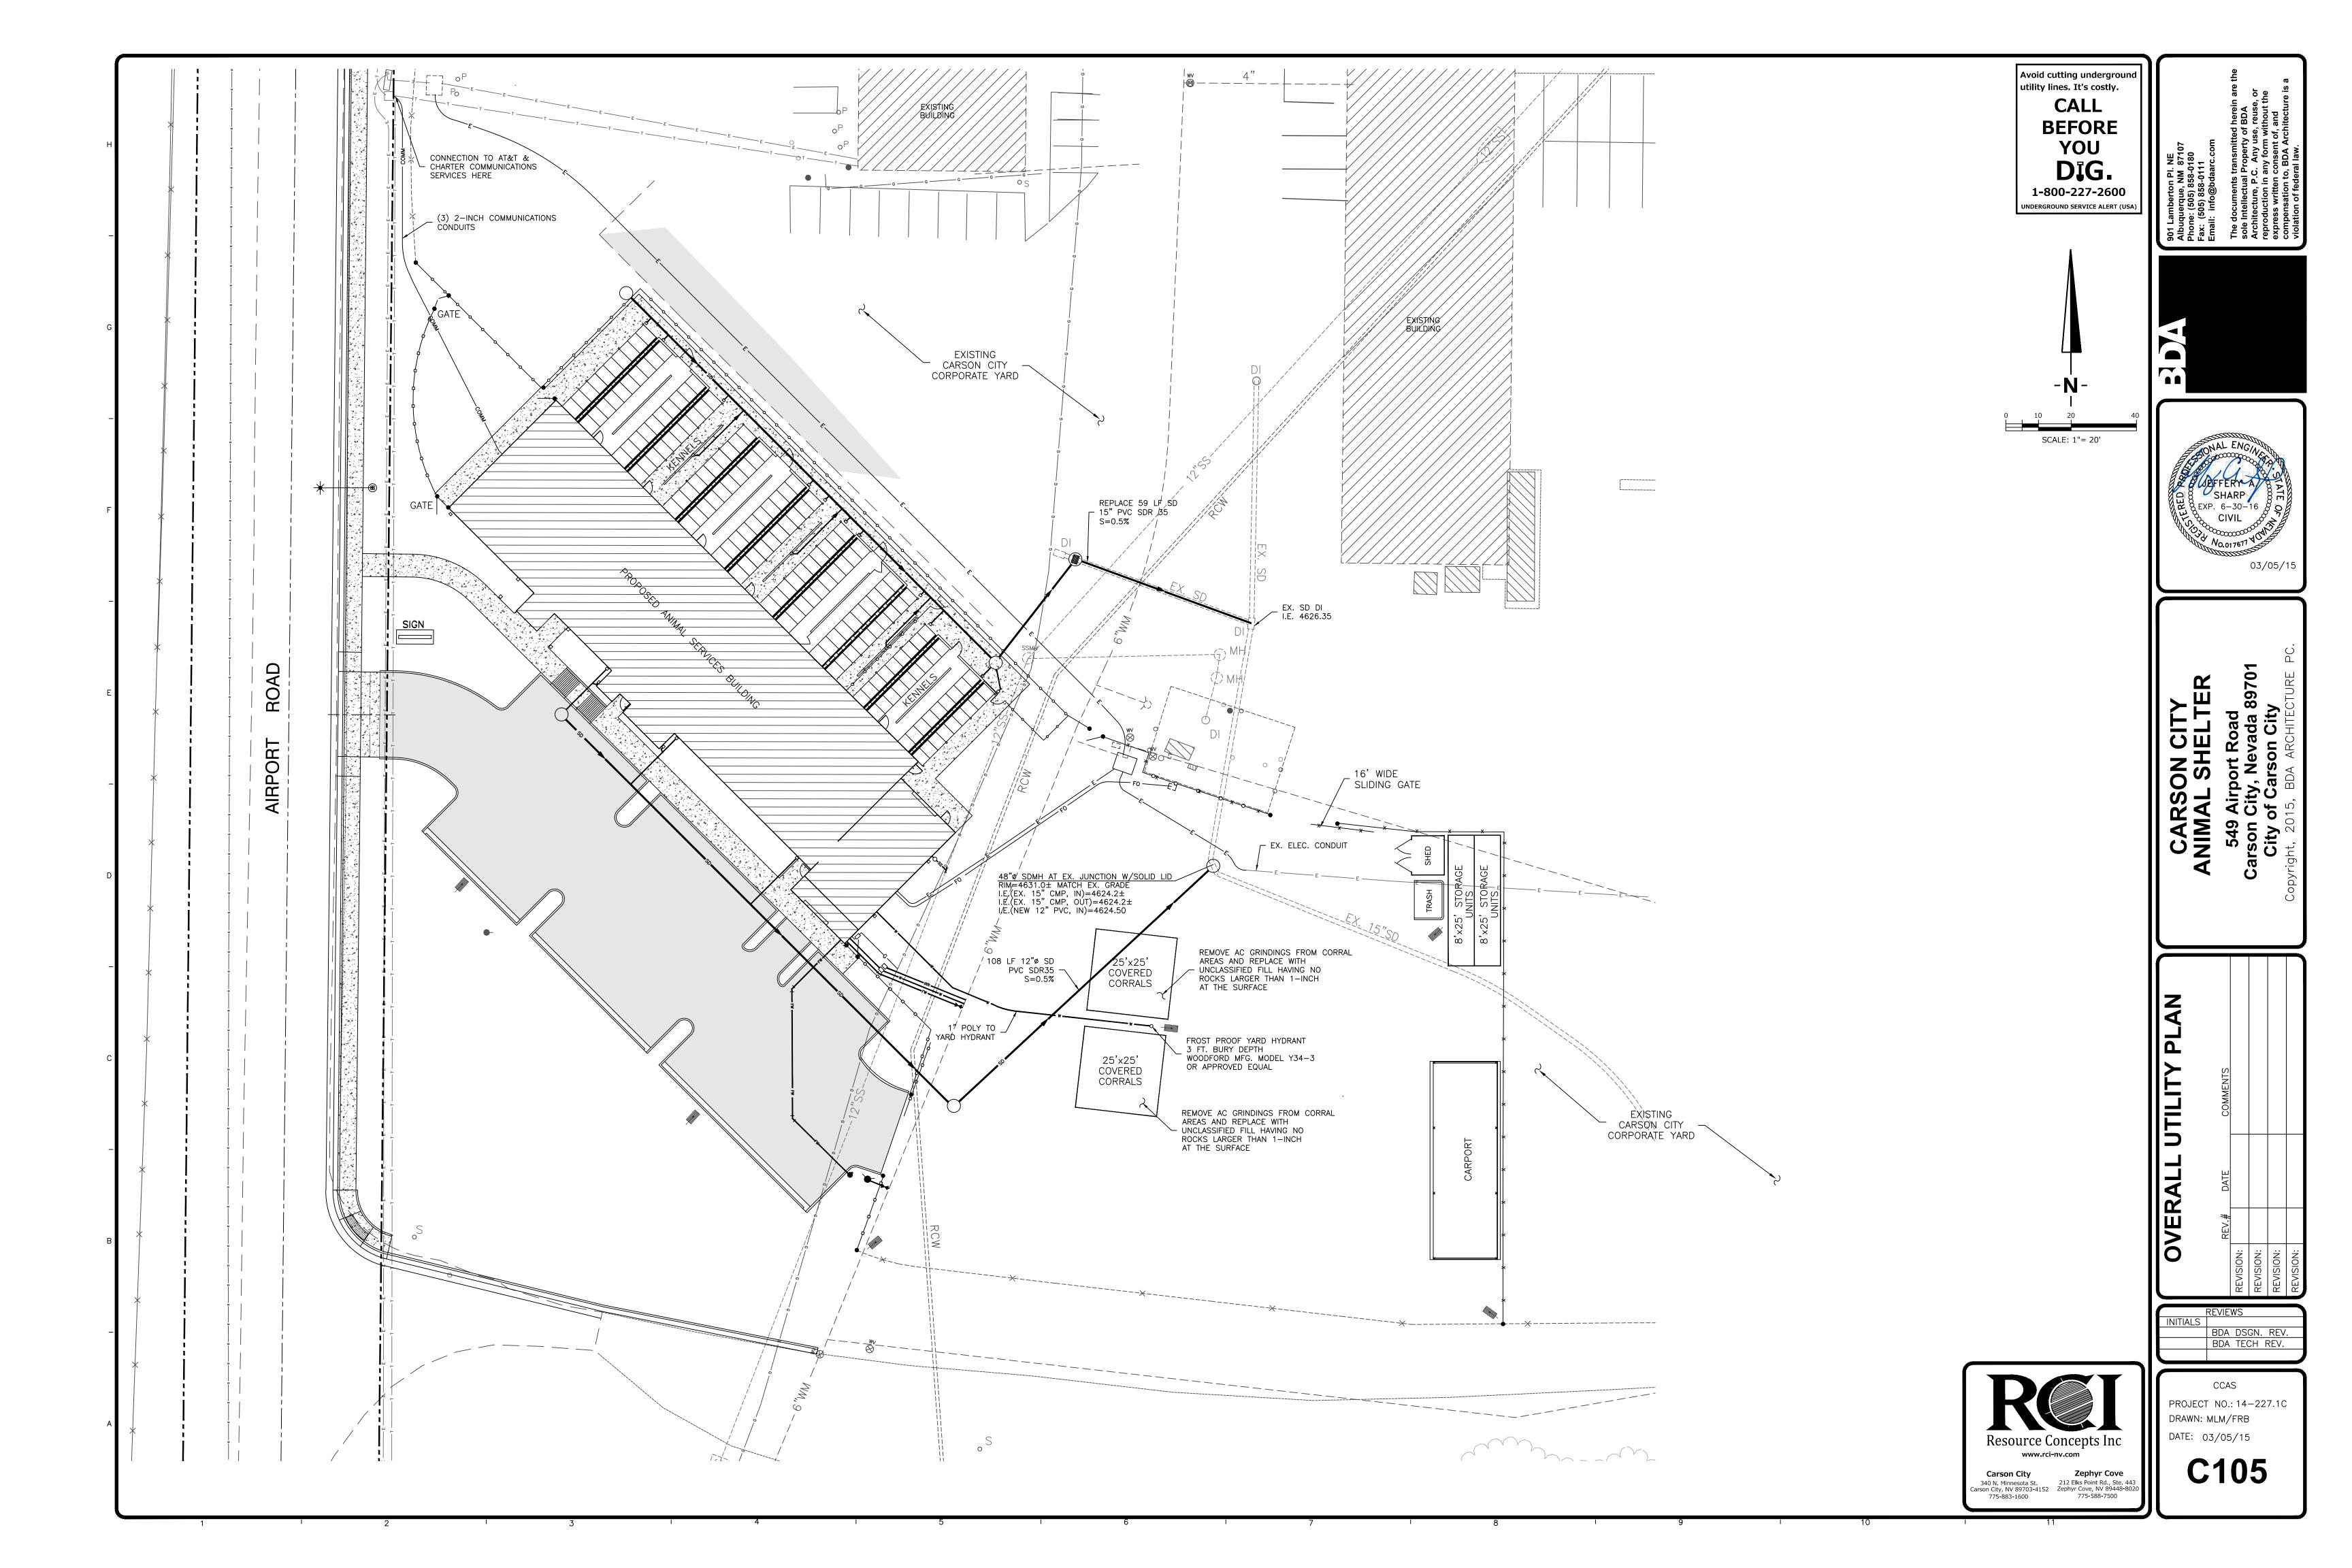

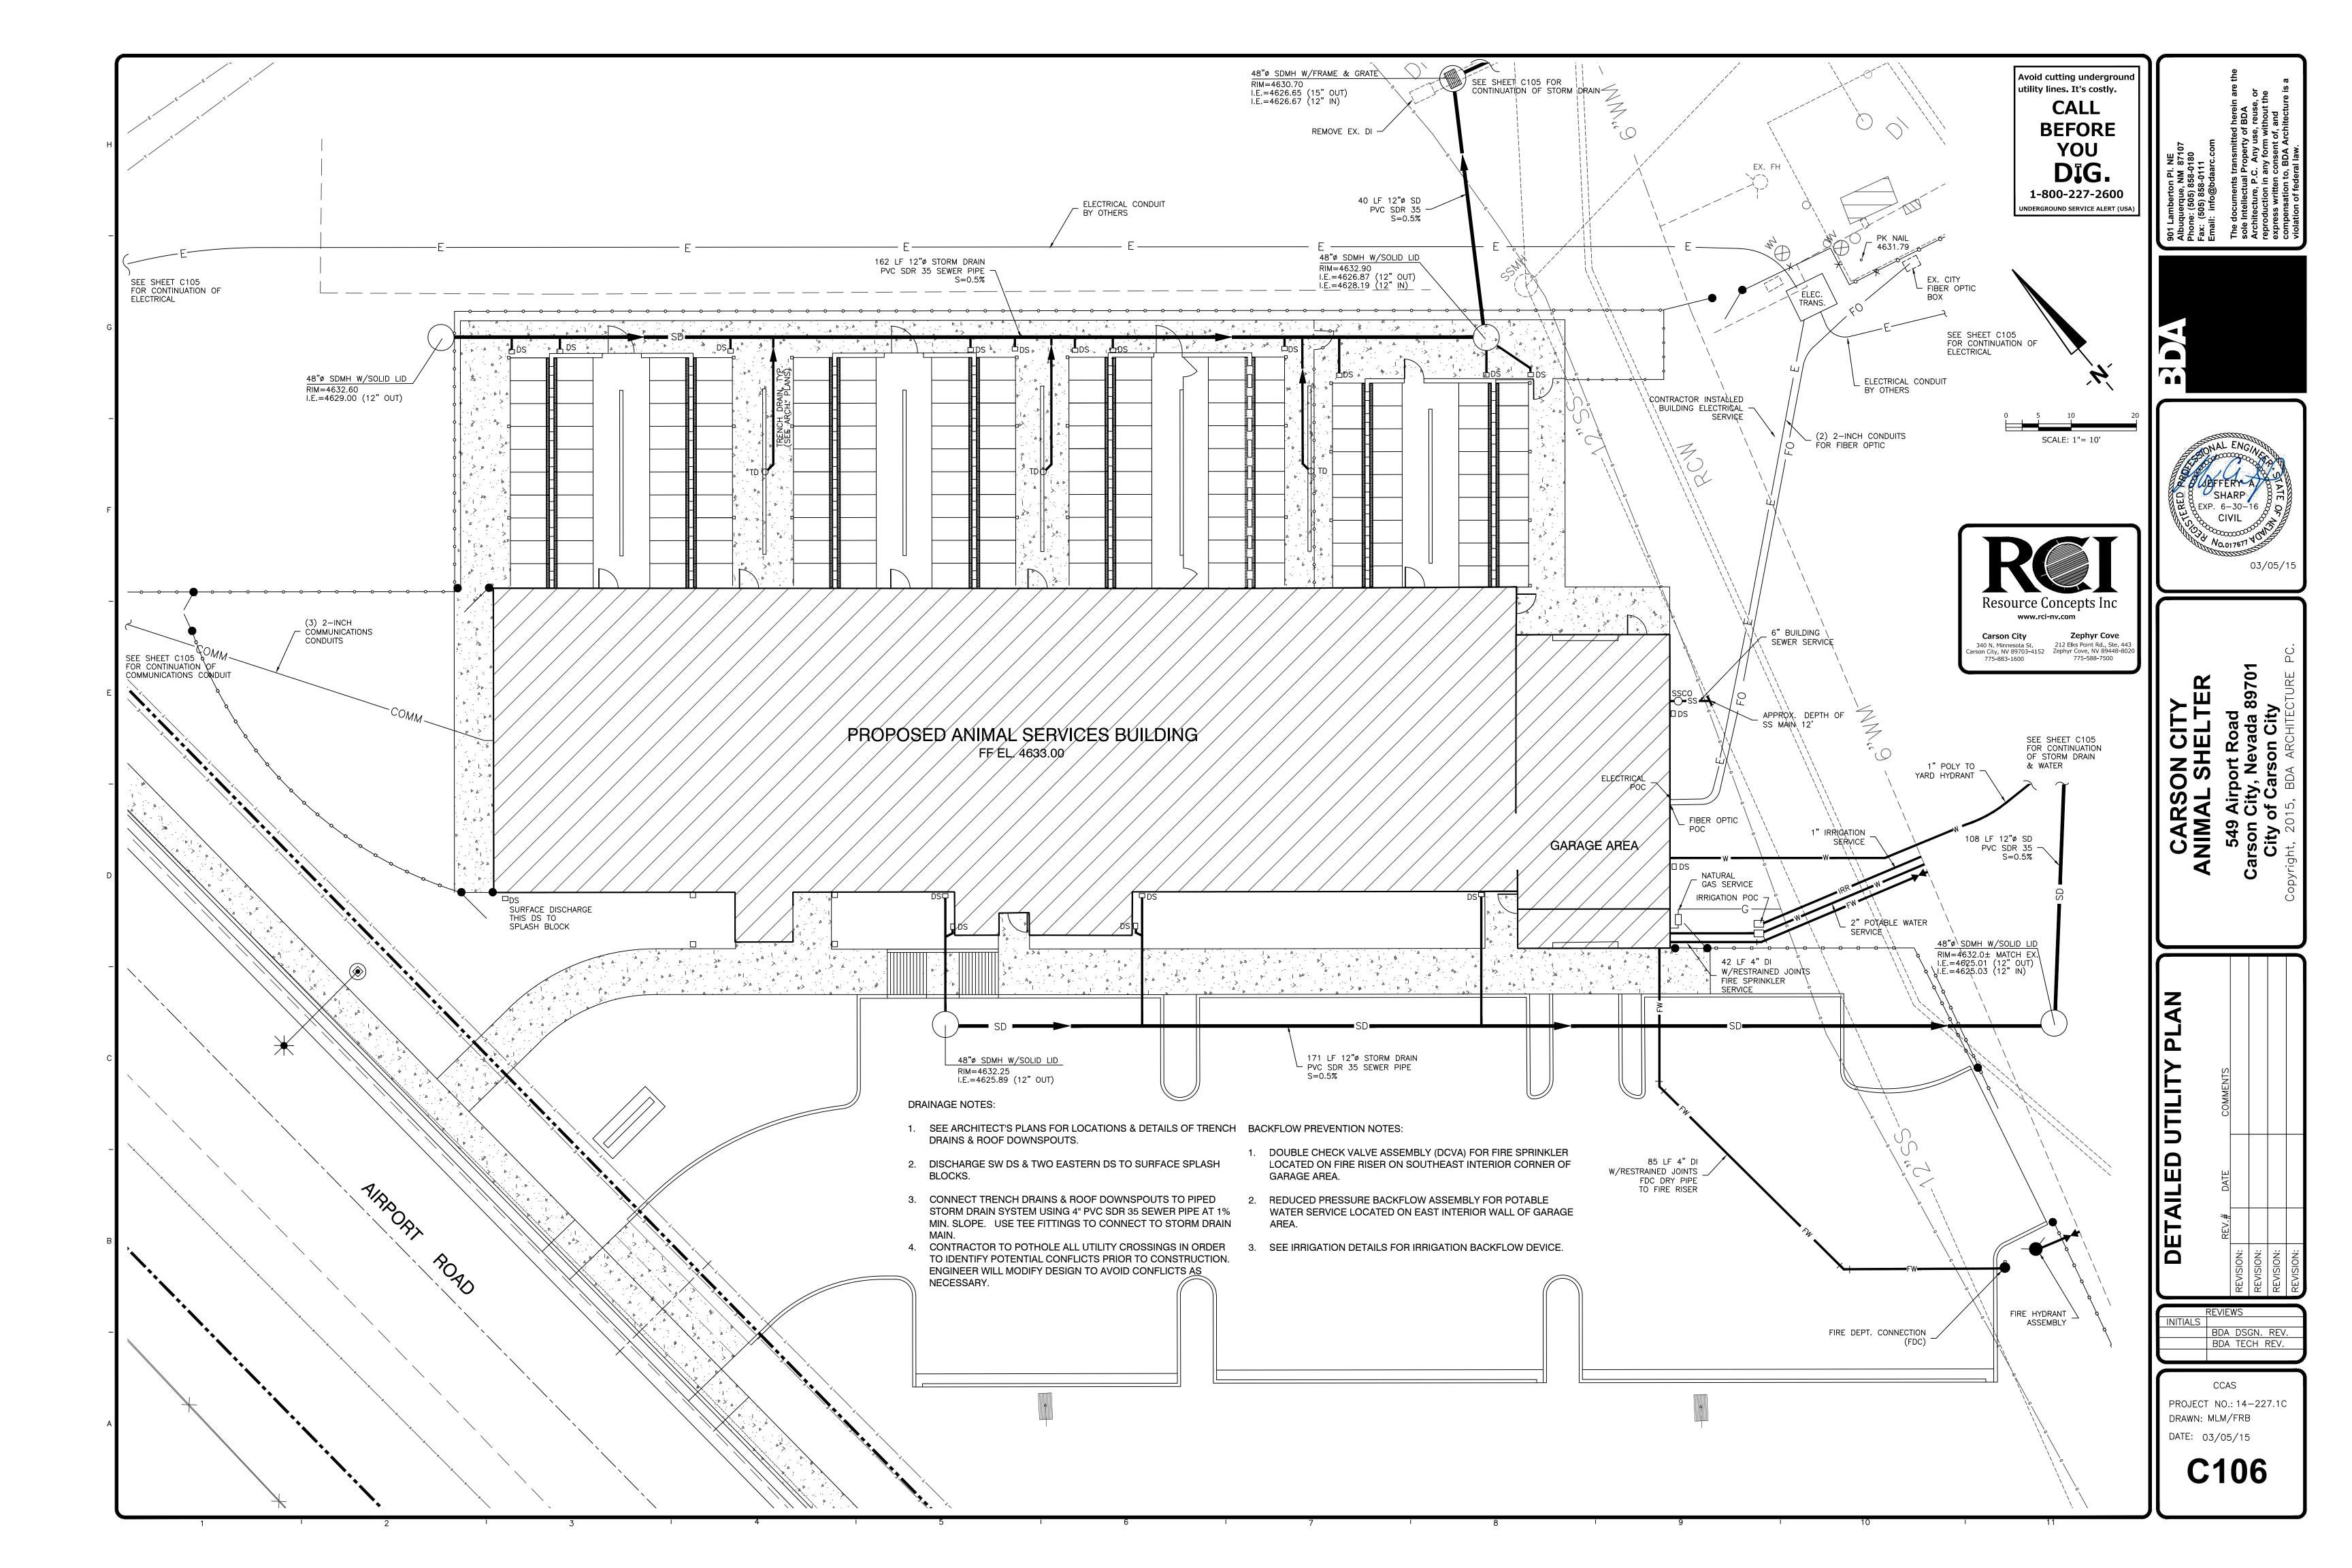

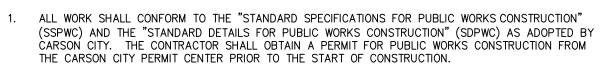

ALL TRAFFIC CONTROL AND BARRICADING WITHIN THE CARSON CITY RIGHT-OF-WAY SHALL CONFORM TO SECTION 100.33, 332.04 AND 332.05 OF THE STANDARD SPECIFICATIONS, PART 6 OF THE MANUAL ON UNIFORM TRAFFIC CONTROL DEVICES, LATEST EDITION, AND THE UNR T2 CENTER, TEMPORARY TRAFFIC CONTROL GUIDELINES LATEST EDITION. A TRAFFIC CONTROL PLAN MUST BE SUBMITTED AND

APPROVED BY THE CARSON CITY ENGINEERING DIVISION PRIOR TO ANY STREET CLOSURES.

- THE CONTRACTOR SHALL CALL UNDERGROUND SERVICE ALERT "CALL BEFORE YOU DIG" (811) OR (1-800-227-2600) AT LEAST TWO (2) WORKING DAYS PRIOR TO START OF CONSTRUCTION AND COMPLY WITH THE REQUIREMENTS OF NRS AND NAC 455 THROUGHOUT THE COURSE OF THE WORK, SEWER SERVICE LATERALS ARE NOT OWNED OR MARKED BY CARSON CITY.
- THE CONTRACTOR SHALL CALL THE CARSON CITY ENGINEERING DIVISION (887-2300) TWO (2) WORKING DAYS PRIOR TO THE START OF CONSTRUCTION. THE CONTRACTOR SHALL CALL ONE (1) WORKING DAY PRIOR TO REQUIRED INSPECTIONS AND TESTING. THE REQUIRED INSPECTIONS AND TESTING ARE LISTED ON THE INSPECTION RECORD ISSUED WITH EACH PERMIT. THE CONTRACTOR MUST HAVE THE PERMIT NUMBER AND THE DESCRIPTION LISTED ON THE INSPECTION RECORD TO SCHEDULE REQUIRED INSPECTIONS AND TESTING. FOR CITY CONTRACTED PROJECTS, THE CONTRACTOR SHALL SCHEDULE INSPECTIONS PER THE CONTRACT DOCUMENTS.
- FINAL INSPECTIONS WILL BE PERFORMED BY CARSON CITY ENGINEERING DIVISION ACCORDING TO THE CARSON CITY INSPECTIONS AND TESTING PROCEDURES. NOTE: THESE PROCEDURES REQUIRE SUBMITTAL OF RECORD DRAWING PRINTS BY THE CONTRACTOR AND 10 WORKING DAYS TO PREPARE A FINAL PUNCH LIST. ALL CONDITIONS OF THE FINAL INSPECTION MUST BE COMPLETED PRIOR TO FINAL ACCEPTANCE OR ANY APPROVAL OF A CERTIFICATE OF OCCUPANCY BY THE CARSON CITY ENGINEERING DIVISION.
- MODIFICATIONS TO THE APPROVED PLANS REQUIRES REVIEW AND APPROVAL BY THE CARSON CITY ENGINEERING DIVISION. WORK PERFORMED WITHOUT WRITTEN APPROVAL BY CARSON CITY ENGINEERING WILL REQUIRE REMOVAL AT THE CONTRACTORS EXPENSE.
- 6. THE APPROVED PLAN, PERMIT AND INSPECTION RECORD MUST BE ON THE JOB SITE AT ALL TIMES.
- 7. PLAN APPROVAL FOR SEWER AND WATER CONSTRUCTION SHALL EXPIRE ONE YEAR FROM DATE OF APPROVAL UNLESS CONSTRUCTION HAS BEEN INITIATED. (CCMC 12.06.180F, 12.01.140D)
- THE CONTRACTOR WILL BE SOLELY AND COMPLETELY RESPONSIBLE FOR ACQUIRING A STORMWATER DISCHARGE PERMIT FROM THE NEVADA DIVISION OF ENVIRONMENTAL PROTECTION (NDEP) INCLUDING DEVELOPING, SUBMITTING AND IMPLEMENTING A STORM WATER POLLUTION PREVENTION PLAN (SWPPP). THE CONTRACTOR SHALL DEVELOP, PLACE AND MAINTAIN STORM WATER PROTECTION DEVICES IN COMPLIANCE WITH THE NEVADA CONTRACTORS FIELD GUIDE FOR CONSTRUCTION SITE BEST MANAGEMENT PRACTICES (JUNE 2008).

NO. | REVISION | DATE | STANDARD DETAIL FOR PUBLIC WORKS CONSTRUCTION | SECTION

GENERAL NOTES

DRAWING NO.

5/2014

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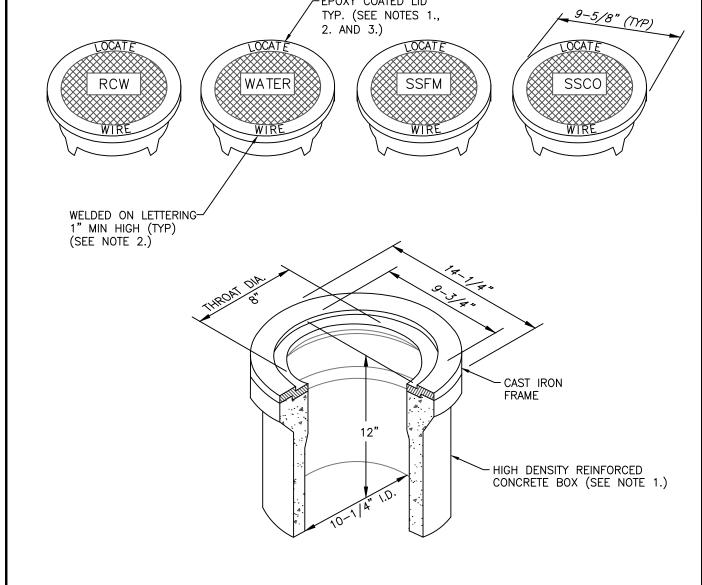
NOTE 2

APPROVED BY: _____ 05/14

BACKFILL TO SUBGRADE IF TRENCH IS IN AN EXISTING PAVEMENT. BACKFILL TO ORIGINAL GROUND IF TRENCH IS OUTSIDE EXISTING PAVEMENT (SEE NOTES 1., 2. & 6.) WARNING TAPE - NON METALLIC (SEE NOTE 7.) TRACER WIRE FOR WATER LINES, RECLAIMED WATER LINES, SEWER FORCE MAINS AND SEWER	
BEDDING MATERIAL - CLASS "A" BACKFILL (SEE NOTE 3.) FORCE MAINS AND SEWER LATERALS (SEE NOTE 8.)	
6"MIN.	
TRENCH SUBGRADE (SEE NOTE 4.) 12" PIPE 12" O.D. MINIMUM TRENCH EXCAVATION LIMITS	
TYPICAL TRENCH SECTION NTS	


- WATER DENSIFIED BACKFILL AND TUNNELING SHALL BE BY SPECIAL PROVISION ONLY.
- BACKFILL SHALL CONFORM TO THE REQUIREMENTS OF CLASS E BACKFILL AS SPECIFIED IN SUBSECTION 200.03.06 OF THE SSPWC. MATERIAL SHALL BE PLACED IN LIFT THICKNESS SPECIFIED IN SUBSECTION 305.10 OF THE SSPWC AND DENSIFIED TO 90% RELATIVE COMPACTION.
- BEDDING SHALL CONFORM TO THE REQUIREMENTS OF CLASS A BACKFILL AS SPECIFIED IN SUBSECTION 200.03.02 OF THE SSPWC. MATERIAL SHALL BE DENSIFIED TO 90% RELATIVE COMPACTION.
- PLANS SHALL INCLUDE A DETAIL FOR SUBGRADE STABILIZATION INCLUDING BACKFILL MATERIAL. STRUCTURAL GEOTEXTILE FILTER FABRIC AND MODIFIED CUTOFF COLLARS WHEN POTENTIAL FOR UNSTABLE SUBGRADES EXIST, SUBJECT TO THE APPROVAL OF THE CARSON CITY ENGINEER OR PUBLIC WORKS DIRECTOR.
- 5. FOR TRENCHES IN ROADWAY SECTION, SEE PAVEMENT PATCH DETAIL (DWG. No. C-5.1.6).
- FOR THE PURPOSE OF PAYMENT; EXCAVATION AND BACKFILL QUANTITIES ARE BASED ON THESE STANDARD DRAWINGS, AND NO ADDITIONAL COMPENSATION WILL BE MADE. SHORING OR SLOPED CUT SLOPES MAY BE NECESSARY, BUT THERE WILL BE NO ADDITIONAL PAYMENT. ALL EXCAVATIONS SHALL CONFORM TO THE LATEST O.S.H.A. REQUIREMENTS.
- PLACE NON METALLIC WARNING TAPE 1 FOOT ABOVE ALL BURIED PIPES AND CONDUITS.
- 8. TRACER WIRE SHALL BE 12 GAUGE (MINIMUM THICKNESS) INSULATED SOLID COPPER OR COPPER-CLAD STEEL CORE WIRE. INSULATION SHALL BE 30 MIL HDPE. PLANS SHALL SPECIFY WIRE STRENGTH AND INSULATION THICKNESS FOR BORING APPLICATIONS. SPLICES SHALL BE CONNECTED BY WIRE NUTS, SEALED WITH AQUA SEAL OR SILICON FILLED, AND DOUBLE WRAPPED WITH U/L LISTED ELECTRICAL TAPE. TRACER WIRE COLOR SHALL BE, BLUE FOR WATER, PURPLE FOR RECLAIMED WATER, AND GREEN FOR SEWER.

NO.	REVISION	DATE	STANDARD DETAIL FOR PUBLIC WORKS CONSTRUCTION	SECTION
				CARSON CITY
			TRENCH EXCAVATION	DRAWING NO. C-1.2.1 (305)
			AND BACKFILL	DATE
APPRO'	VED BY: B	7/09	AND DACKFILL	7/2009



- 1. BOX AND LID SHALL BE TRAFFIC RATED WITH A MINIMUM INSIDE DIAMETER OF 10 INCHES (CHRISTY G3 TRAFFIC VALVE BOX & LID).
- 2. CAST IRON LID SHALL BE MARKED AT THE FACTORY "LOCATE WIRE", AND "WATER" FOR WATER APPLICATIONS, "RCW" FOR RECLAIMED WATER APPLICATIONS, "SSFM" FOR SANITARY SEWER FORCE MAIN APPLICATIONS, AND "SSCO" FOR SANITARY SEWER CLEANOUT APPLICATIONS.
- 3. CAST IRON LID SHALL BE EPOXY COATED AT THE FACTORY, OR POWDER COATED, COLOR SHALL BE BLUE FOR WATER APPLICATIONS, PURPLE FOR RECLAIMED WATER APPLICATIONS AND GREEN FOR SANITARY SEWER APPLICATIONS.
- 4. BOX SHALL BE SET OR ADJUSTED TO GRADE PER DRAWING NO. C-3.1.4, RISER FOR ADJUSTED BOX SHALL BE PER DRAWING NO. C-3.1.4 FOR OVERLAY ADJUSTMENTS, RISER WILL NOT REQUIRE REPLACEMENT OR EXTENSION IF IT EXTENDS A MINIMUM OF 2 INCHES INTO ADJUSTED BOX.


	REVISION	DATE	STANDARD DETAIL FOR PUBLIC WORKS CONSTRUCTION	SECTION
				CARSON CITY
			LINE LOCATION	DRAWING NO. C-1.2.2 (306,307)
			ROY & LID	DATE (306,307)
0٧	ED BY: <u>. Ø</u>	7/09	DOX & LID	7/2009
	1			

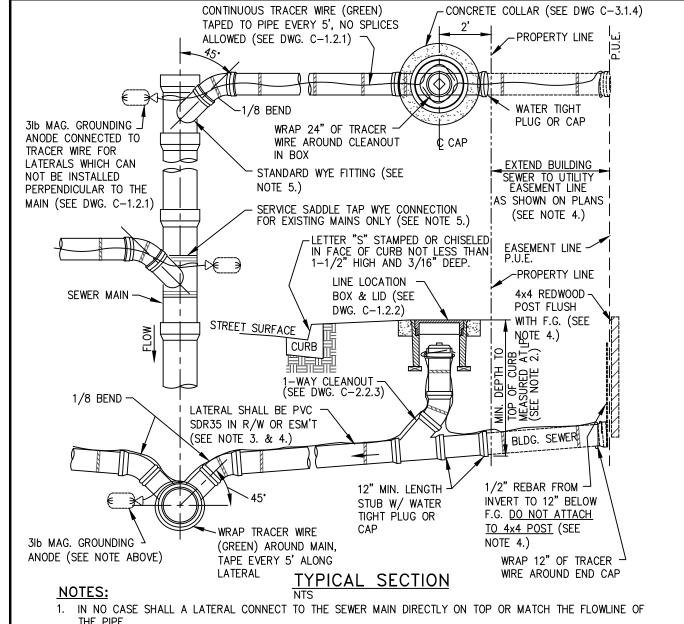

- 2. SEWER LATERALS SHALL HAVE A MINIMUM SLOPE OF 2%. PLANS SHALL INDICATE INVERT ELEV. REQUIRED TO SERVE PROPERTY AND CLEAR UNDERGROUND OBSTRUCTIONS.
- 3. ALL JOINTS ON SEWER LATERAL PIPE WITHIN THE RIGHT-OF-WAY SHALL BE COMPRESSION TYPE. C900 PVC MAY BE SUBSTITUTED FOR SDR35 TO MEET NDEP BSDW SEPARATIONS.
- 4. LATERAL SHALL BE PERPENDICULAR TO THE MAIN AND EXTEND TO PROPERTY LINE. WHEN SHOWN ON PLANS TO INSTALL BUILDING SEWER PRIOR TO PUBLIC UTILITIES, INSTALLATION OF BUILDING SEWER IS EXTENDED TO UTILITY EASEMENT LINE AND STANDARD WATERTIGHT PLUG OR CAP, REDWOOD POST AND REBAR SHALL BE INSTALLED AT EASEMENT LINE.
- 5. USE OF SEWER SERVICE TAP SADDLE CONNECTIONS SHALL NOT BE ALLOWED FOR NEW SEWER MAIN CONSTRUCTION. WHEN A TAP SADDLE CONNECTION IS TO BE USED ON AN EXISTING SEWER MAIN, IT SHALL BE
- A WYE SADDLE AND BE INSTALLED PER DWG. C-2.2.2. 6. DISCONTINUANCE OF USE OF AN EXISTING SEWER LATERAL REQUIRES ABANDONMENT OF THE LATERAL. CUT, REMOVE 1 FOOT OF EXISTING LATERAL AND CAP BOTH ENDS OF THE EXISTING SEWER LATERAL TO BE
- ABANDONED WITHIN 6 INCHES OF THE SEWER MAIN. INSPECTION BY CARSON CITY SEWER UTILITY IS REQUIRED PRIOR TO BACKFILL 7. PROPERTY OWNER SHALL BE RESPONSIBLE FOR OPERATION, MAINTENANCE AND REPAIR OF THE SEWER


LATERAL WITHIN THE PUBLIC RIGHT-OF-WAY PER CCMC 12.05.050.5.


REVISION	DATE	STANDARD DETAIL FOR PUBLIC WORKS CONSTRUCTION	SECTION
			CARSON CITY
		SEWER LATERAL	DRAWING NO.
		JEWER LAIERAL	C-2.2.1 (203,306 DATE
VED BY: B	07/09		7/2009
7			

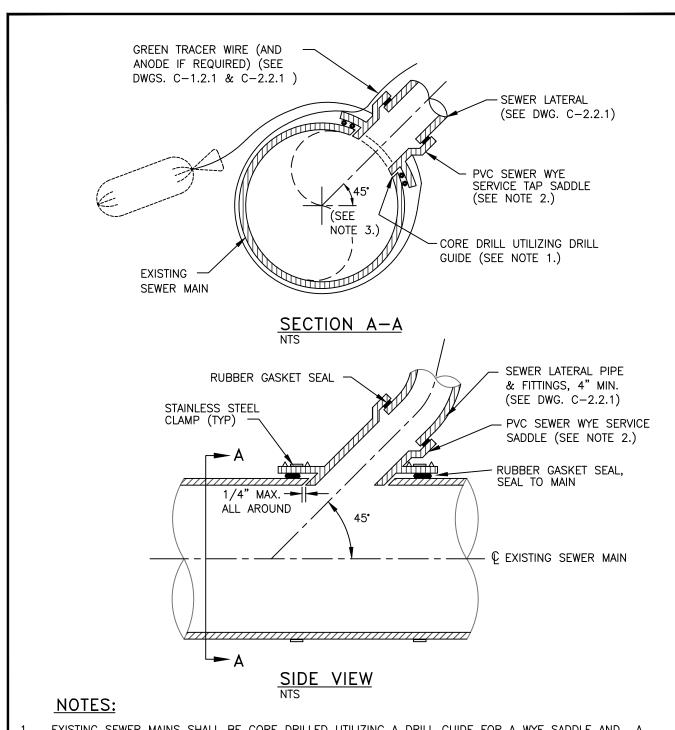



- EXISTING SEWER MAINS SHALL BE CORE DRILLED UTILIZING A DRILL GUIDE FOR A WYE SADDLE AND A CORE DRILL WITH A LENGTH EXCEEDING THE LATERAL DIAMETER, INSERT-A-DRILL IDY75 & EXTRA LONG HOLE SAW OR APPROVED EQUAL. DIAMOND CORE BITS SHALL BE USED ON NON-PVC MAINS.
- SERVICE TAP SADDLES SHALL BE PVC SEWER WYE SADDLES. A ROMAC STYLE "CB" SEWER SADDLE OR /\(\frac{1}{\chi}\) APPROVED EQUAL MAY BE USED ON EXISTING SEWER MAINS ONLY WHEN MAIN IS NOT PVC.
- SADDLES SHALL BE INSTALLED AT 45 DEGREES TO MAIN AS SHOWN IN SECTION A-A. IN NO CASE SHALL A LATERAL CONNECTING TO THE EXISTING SEWER MAIN BE LOCATED DIRECTLY ON TOP OF THE PIPE, NOR SHALL IT MATCH THE FLOWLINE OF THE PIPE.


NO.	REVISION	DATE	STANDARD DETAIL FOR PUBLIC WORKS CONSTRUCTION	SECTION
<u> </u>	NOTE 2	7/12	05///50 050///05	CARSON CITY
			SEWER SERVICE	DRAWING NO. C-2.2.2 (203,306)
			TAP SADDIF	DATE
APPROVI	ED BY:	7/09	TAI SAUULL	7/2009

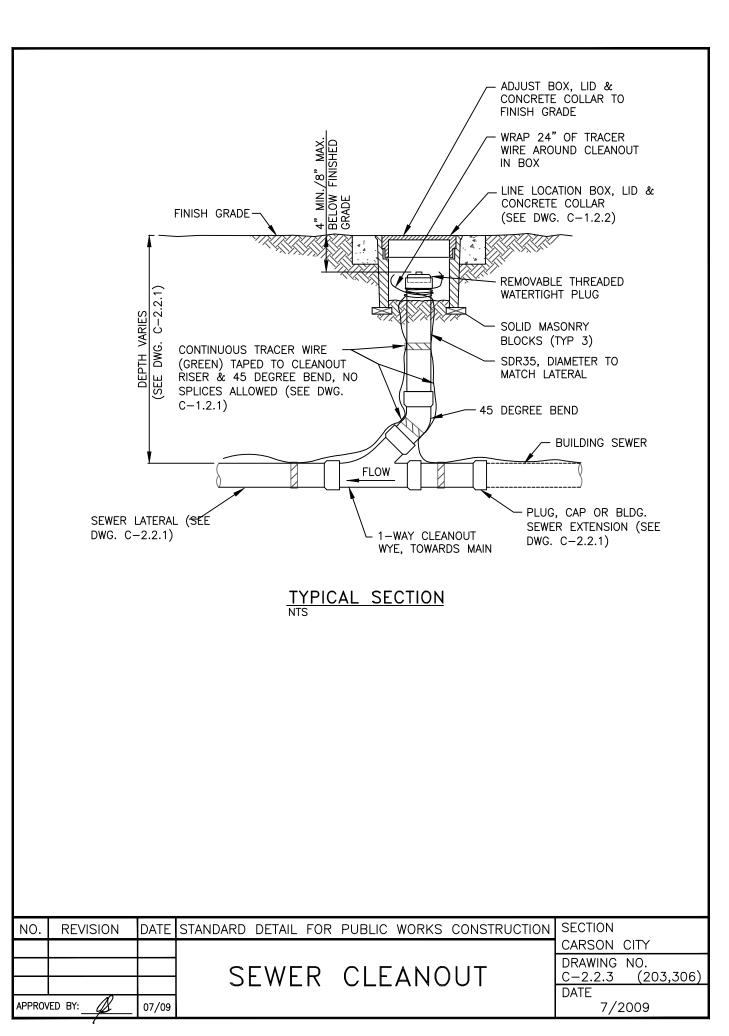

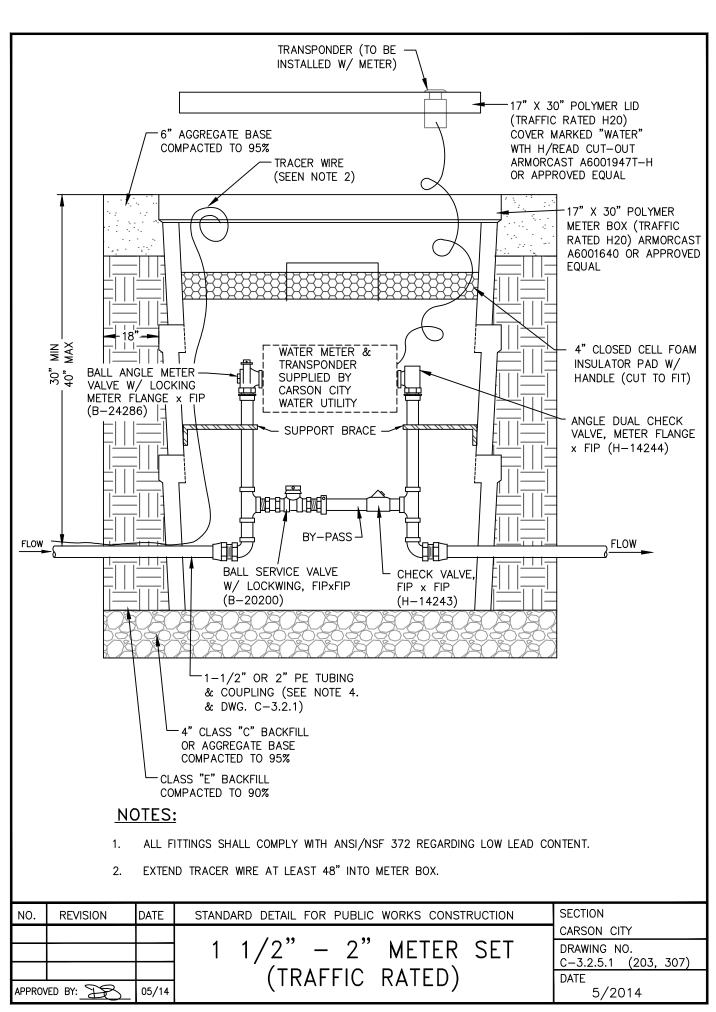

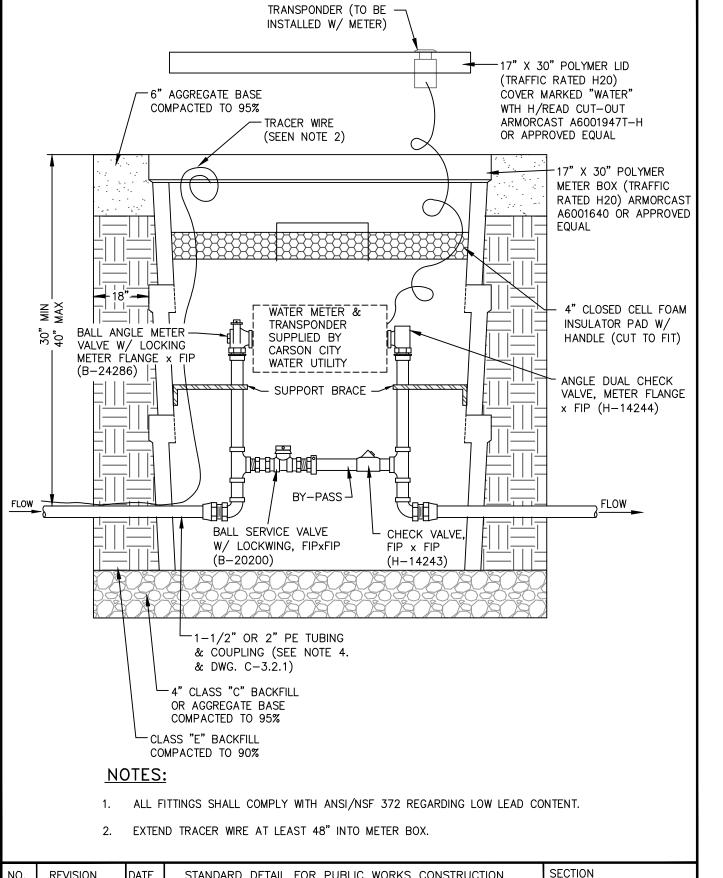


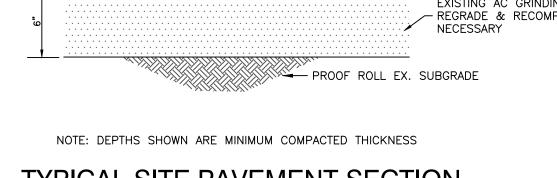

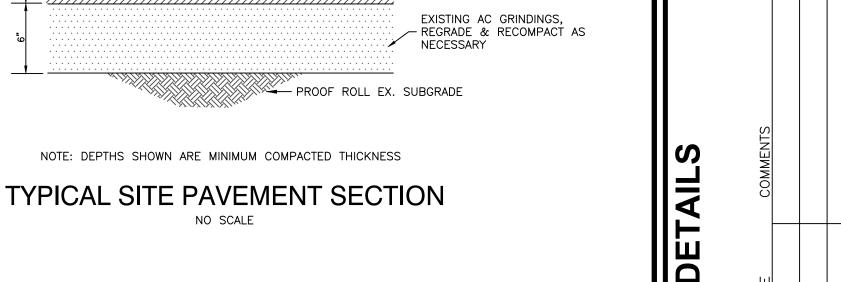

- AC PAVING



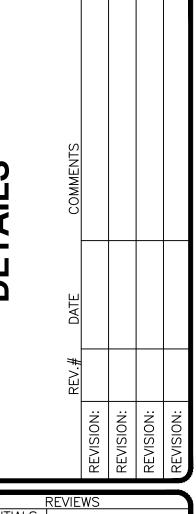


SHARP

CIVIL

03/05/15

PROJECT NO.: 14-227.1C DRAWN: MLM/FRB DATE: 03/05/15

BDA TECH REV.

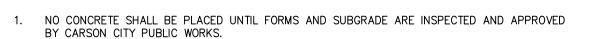

- 2. PORTLAND CEMENT CONCRETE (P.C.C.) SHALL HAVE THE FOLLOWING CHARACTERISTICS: SYNTHETIC FIBER-REINFORCEMENT (AT A MINIMUM OF 1 POUND PER CUBIC YARD), WITH COARSE AGGREGATE GRADATION CONFORMING TO SIZE No. 67 PER SECTION 200.05.03 OF THE STANDARD SPECIFICATIONS, AND SHALL HAVE A 1 TO 4 INCH SLUMP, AND 4 TO 7 PERCENT ENTRAINED AIR. 4000 PSI MIN COMPRESSIVE STRENGTH @ 28 DAYS, MIN 6 SACKS OF TYPE II CEMENT PER CUBIC YARD WITH A MAX. WATER/CEMENT RATIO OF 0.45, AIR ENTRAINMENT 6% ±1.5%, SLUMP AT 1 TO 4 INCHES ALL MATERIALS SHALL CONFORM TO SSPWC SECTION 202. OF THE STANDARD SPECIFICATIONS FOR PUBLIC WORKS CONSTRUCTION.
- 3. ALL CONCRETE EDGING AND JOINTING SHALL BE CONSTRUCTED IN ACCORDANCE WITH STD. DETAIL C-5.1.1 AND CONFORM TO SEC. 312.09 OF THE STANDARD SPECIFICATIONS FOR PUBLIC WORKS CONSTRUCTION (SSPWC).
- 4. IF OBSTRUCTIONS SUCH AS INLETS, UTILITY POLES, FIRE HYDRANTS, ETC. ARE ENCOUNTERED. THE LOCATION AND DIMENSIONS MAY BE ADJUSTED UPON APPROVAL BY CARSON CITY PUBLIC WORKS. A MINIMUM SURFACE OF 5 FEET X 5 FEET CLEAR IS REQUIRED WHEN DIRECTION OF TRAVEL MAY CHANGE AND A MINIMUM SURFACE OF 4 FEET CLEAR IS REQUIRED WHERE DIRECTION OF TRAVEL IS NOT EXPECTED TO CHANGE, UNLESS OTHERWISE APPROVED BY THE CARSON CITY ENGINEER OR PUBLIC WORKS DIRECTOR.
- 5. EXISTING CONCRETE SHALL BE REMOVED TO A NEAT SAWCUT LINE OR NEAREST EXPANSION JOINT.
- 6. ALL AGGREGATE BASE SHALL BE TYPE 2, CLASS B AND SHALL CONFORM TO SEC.200.01. OF THE STANDARD SPECIFICATIONS FOR PUBLIC WORKS CONSTRUCTION (SSPWC).
- 7. NEW CONCRETE SHALL HAVE A HEAVY BROOM FINISH PERPENDICULAR TO SIDEWALK.
- 8. AC PAVEMENT EDGE SHALL BE 1/4 INCH TO 1/2 INCH ABOVE THE LIP OF GUTTER. EXCEPTION: AC PAVEMENT EDGE SHALL BE FLUSH TO 1/4 INCH ABOVE THE LIP OF GUTTER WHEN LOCATED ADJACENT TO A PEDESTRIAN RAMP, WITHIN AN ACCESSIBLE ROUTE OR BIKE LANE.

NO. REVISION DATE STANDARD DETAIL FOR PUBLIC WORKS CONSTRUCTION SECTION

SIDEWALK AND DRIVEWAY

GENERAL NOTES

TYPE 1 CURB & GUTTER


1/2" EXPANSION JOINT

WEAKENED PLANE JOINTS (TYP) CURB & JOINT (TYP) GUTTER A JOINT (TYP) GUTTER A JOINT (TYP) GUTTER A JOINT (TYP) GUTTER	
INSTALL CURB RAMP 15' MIN RADIUS (SEE NOTE 1.)	
(SEE NOTE 3 DWG C-5.2.1) 208 1:50	
PLAN NTS PLAN N	
CURB & GUTTER (SEE NOTE 2.) SLOPE 1/4" PER FOOT 4" CONC 4" MIN. AGG BASE COMPACTED TO 95%	
SECTION A-A NTS	
NOTES:	

NOTES:

- MINIMUM CURB RETURN RADIUS SHALL BE 15 FEET UNLESS OTHERWISE APPROVED BY THE CARSON CITY ENGINEER OR PUBLIC WORKS DIRECTOR.
- 2. SOME STREETS MAY REQUIRE WIDER SIDEWALKS.

NO.	REVISION	DATE	STANDARD DETAIL FOR PUBLIC WORKS CONSTRUCTION	SECTION
				CARSON CITY
			TYPF "A" SIDFWALK	DRAWING NO. C-5.2.2
			TYPE "A" SIDEWALK	DATE
APPRO\	/ED BY:	7/09		7/2009

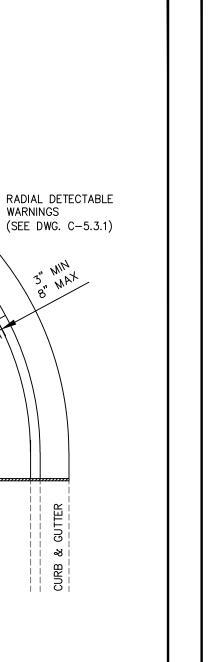

DRAWING NO.

5/2014

'↑ NOTE 8

APPROVED BY: _____ 05/14

CURB & GUTTER

RETAINING CURB MAINTAIN GRADE -

(SEE DWG C-5.3.10)

OF SIDEWALK ADJACENT TO RAMP

1/2" EXPANSION JOINT —


- 1. NOT FOR USE WITH OFFSET SIDEWALKS.
- 2. RETAINING CURBS ARE TO BE USED IN ALL CASES AND FINISH GRADE AT BACK OF SIDEWALK IS TO BE RAISED TO TOP OF RETAINING CURB ELEVATION.

<u>PLAN</u>

NTS


3. SEE "CURB RAMP GENERAL NOTES" DWG C-5.3.1 FOR FURTHER REQUIREMENTS.


NO.	REVISION	DATE	STANDARD DETAIL FOR PUBLIC WORKS CONSTRUCTION	SECTION
			PARALLEL CURB RAMP	CARSON CITY DRAWING NO. C-5.3.5
APPRO	VED BY:	7/09	APEX	DATE 7/2009

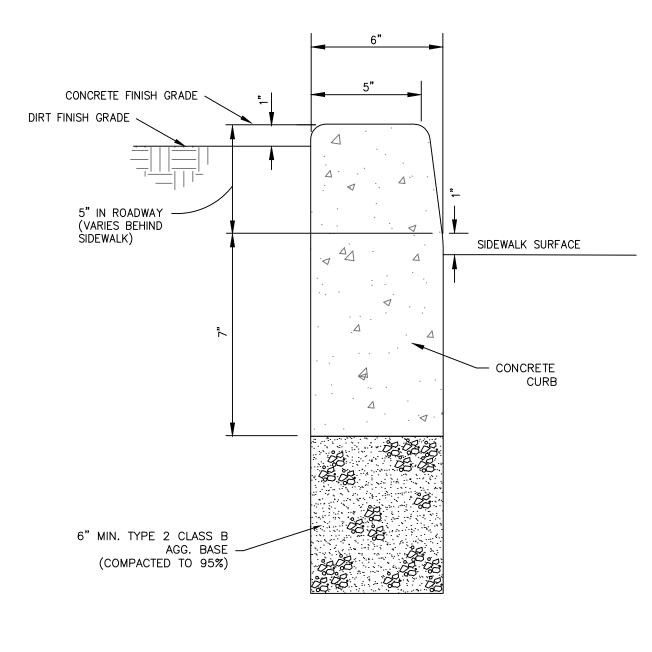


NO CONCRETE SHALL BE PLACED UNTIL FORMS AND SUBGRADE ARE INSPECTED BY CARSON CITY PUBLIC WORKS ALL CONCRETE EDGING AND JOINTING SHALL BE CONSTRUCTED IN ACCORDANCE WITH STD. DETAIL 5.1.1 AND CONFORM TO SEC. 312.09 OF THE STANDARD SPECIFICATIONS FOR PUBLIC WORKS CONSTRUCTION (SSPWC).

NO.	REVISION	DATE	STANDARD DETAIL FOR PUBLIC WORKS CONSTRUCTION	SECTION
				CARSON CITY
				DRAWING NO. C-5.3.10
			P.C.C. RETAINING CURB	DATE
APPROV	ED BY:	7/09		7/2009

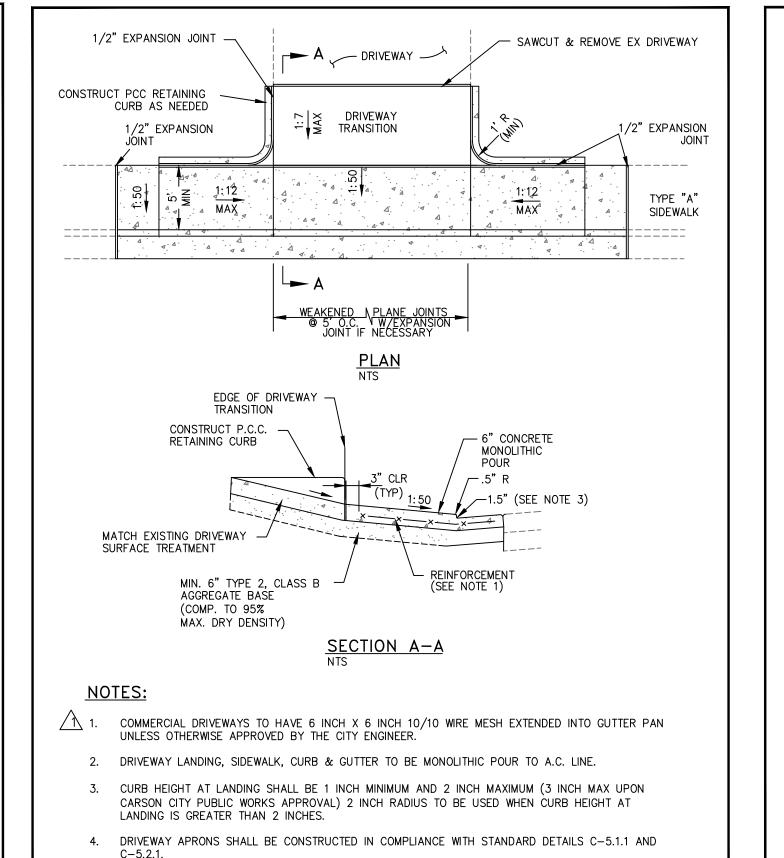

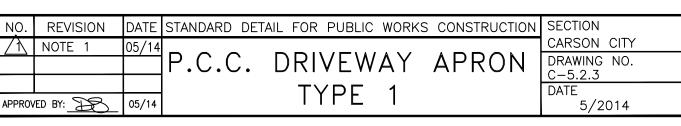

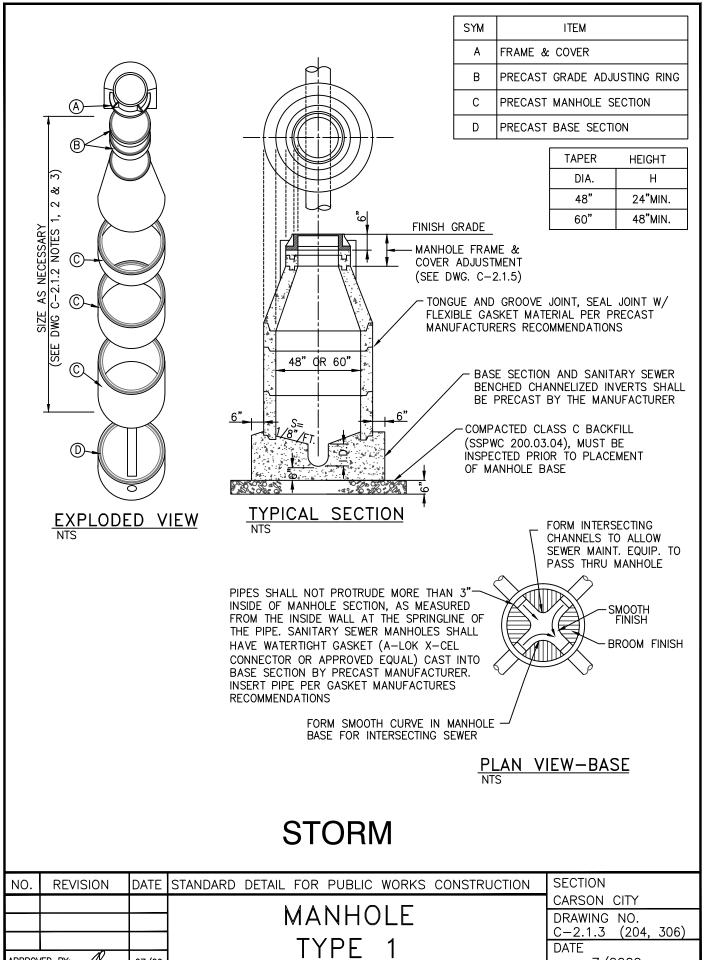

7/2009

APPROVED BY:

- 1. NO CONCRETE SHALL BE PLACED UNTIL FORMS AND SUBGRADE ARE INSPECTED BY CARSON CITY ENGINEERING DIVISION.
- 2. PORTLAND CEMENT CONCRETE (P.C.C.) SHALL HAVE THE FOLLOWING CHARACTERISTICS: SYNTHETIC FIBER-REINFORCEMENT (AT A MINIMUM OF 1 POUND PER CUBIC YARD), 4000 PSI MIN COMPRESSIVE STRENGTH @ 28 DAYS, MIN 6 SACKS OF CEMENT PER CUBIC YARDS WITH A MAX. WATER/CEMENT RATIO OF 0.45, AIR ENTRAINMENT 6% ±1.5%, SLUMP AT 1 TO 4 INCHES ALL MATERIALS SHALL CONFORM TO SSPWC SECTION 202. OF THE STANDARD SPECIFICATIONS FOR PUBLIC WORKS CONSTRUCTION.
- 3. ALL CONCRETE EDGING AND JOINTING SHALL BE CONSTRUCTED IN ACCORDANCE WITH STD. DETAIL C-5.1.1 AND CONFORM TO SEC. 312.09 OF THE STANDARD SPECIFICATIONS FOR PUBLIC WORKS CONSTRUCTION (SSPWC).
- 4. IF OBSTRUCTIONS SUCH AS INLETS, UTILITY POLES, FIRE HYDRANTS, ETC. ARE ENCOUNTERED, THE LOCATION AND DIMENSIONS MAY BE ADJUSTED UPON APPROVAL BY CARSON CITY ENGINEER OR PUBLIC WORKS DIRECTOR, A MINIMUM LANDING OF 5 FEET X 5 FEET CLEAR IS REQUIRED WHEN DIRECTION OF TRAVEL MAY CHANGE. A MINIMUM OF 4 FEET CLEAR IS MAY BE USED UPON APPROVAL OF THE CARSON CITY ENGINEER OR PUBLIC WORKS DIRECTOR WHERE DIRECTION OF TRAVEL IS NOT EXPECTED TO CHANGE.
- 5. WHEN A CROSSWALK IS SERVICED BY RAMP, LANDINGS SHALL BE CONTAINED WITHIN THE CROSSWALK
- 6. EXISTING CONCRETE SHALL BE REMOVED TO A NEAT SAWCUT LINE OR NEAREST EXPANSION JOINT.
- 7. PLANTMIX BITUMINOUS SURFACE SHALL BE FLUSH WITH THE EDGE OF THE GUTTER PAN IN THE AREA OF THE CURB RAMP. GUTTER SHALL MAINTAIN POSITIVE DRAINAGE TO PREVENT PONDING.
- 8. ALL AGGREGATE BASE SHALL BE TYPE 2, CLASS B AND SHALL CONFORM TO SEC.200.01. OF THE STANDARD SPECIFICATIONS FOR PUBLIC WORKS CONSTRUCTION (SSPWC).
- 9. NEW CONCRETE SHALL HAVE A HEAVY BROOM FINISH PERPENDICULAR TO SIDEWALK.
- 10. DETECTABLE WARNINGS SHALL BE EAST JORDAN IRON WORKS 7005 SERIES CAST IRON DETECTABLE WARNING PLATES OR APPROVED EQUAL. INSTALLED PER MANUFACTURERS INSTALLATION GUIDELINES AND CONFORM TO ADAAG (4.29) "DETECTABLE WARNINGS". COLOR: ASPHALT DIPPED UNLESS OTHERWISE APPROVED BY CARSON CITY ENGINEER OR PUBLIC WORKS DIRECTOR. RADIAL DETECTABLE WARNINGS SHALL BE USED WHEN REQUIRED TO MAINTAIN MINIMUM CLEARANCE OF 3
- INCHES AND MAXIMUM CLEARANCE OF 8 INCHES FROM DETECTABLE WARNINGS TO BACK FACE OF CURB. RADIAL DETECTABLE WARNINGS SHALL HAVE A RADIUS WITHIN 5 FEET OF BACK FACE OF
- 11. AC PAVEMENT EDGE SHALL BE 1/4 INCH TO 1/2 INCH ABOVE THE LIP OF GUTTER. EXCEPTION: AC PAVEMENT EDGE SHALL BE FLUSH TO 1/4 INCH ABOVE THE LIP OF GUTTER WHEN LOCATED ADJACENT TO A PEDESTRIAN RAMP OR WITHIN AN ACCESSIBLE ROUTE.

NO.	REVISION	DATE	STANDARD DETAIL FOR PUBLIC WORKS CONSTRUCTION	SECTION
/ \	NOTE 11	6/12		CARSON CITY
			CURB RAMP	DRAWING NO.
				C-5.3.1
	10	+	I GENERAL NOTES	DATE
APPROV	ED BY: //X	6/12		6/2012




89

BDA TECH REV.

PROJECT NO.: 14-227.1C DRAWN: MLM/FRB

Resource Concepts Inc Carson City 340 N. Minnesota St. 212 Elks Point Rd., Ste. 443 Carson City, NV 89703-4152 775-883-1600 775-588-7500

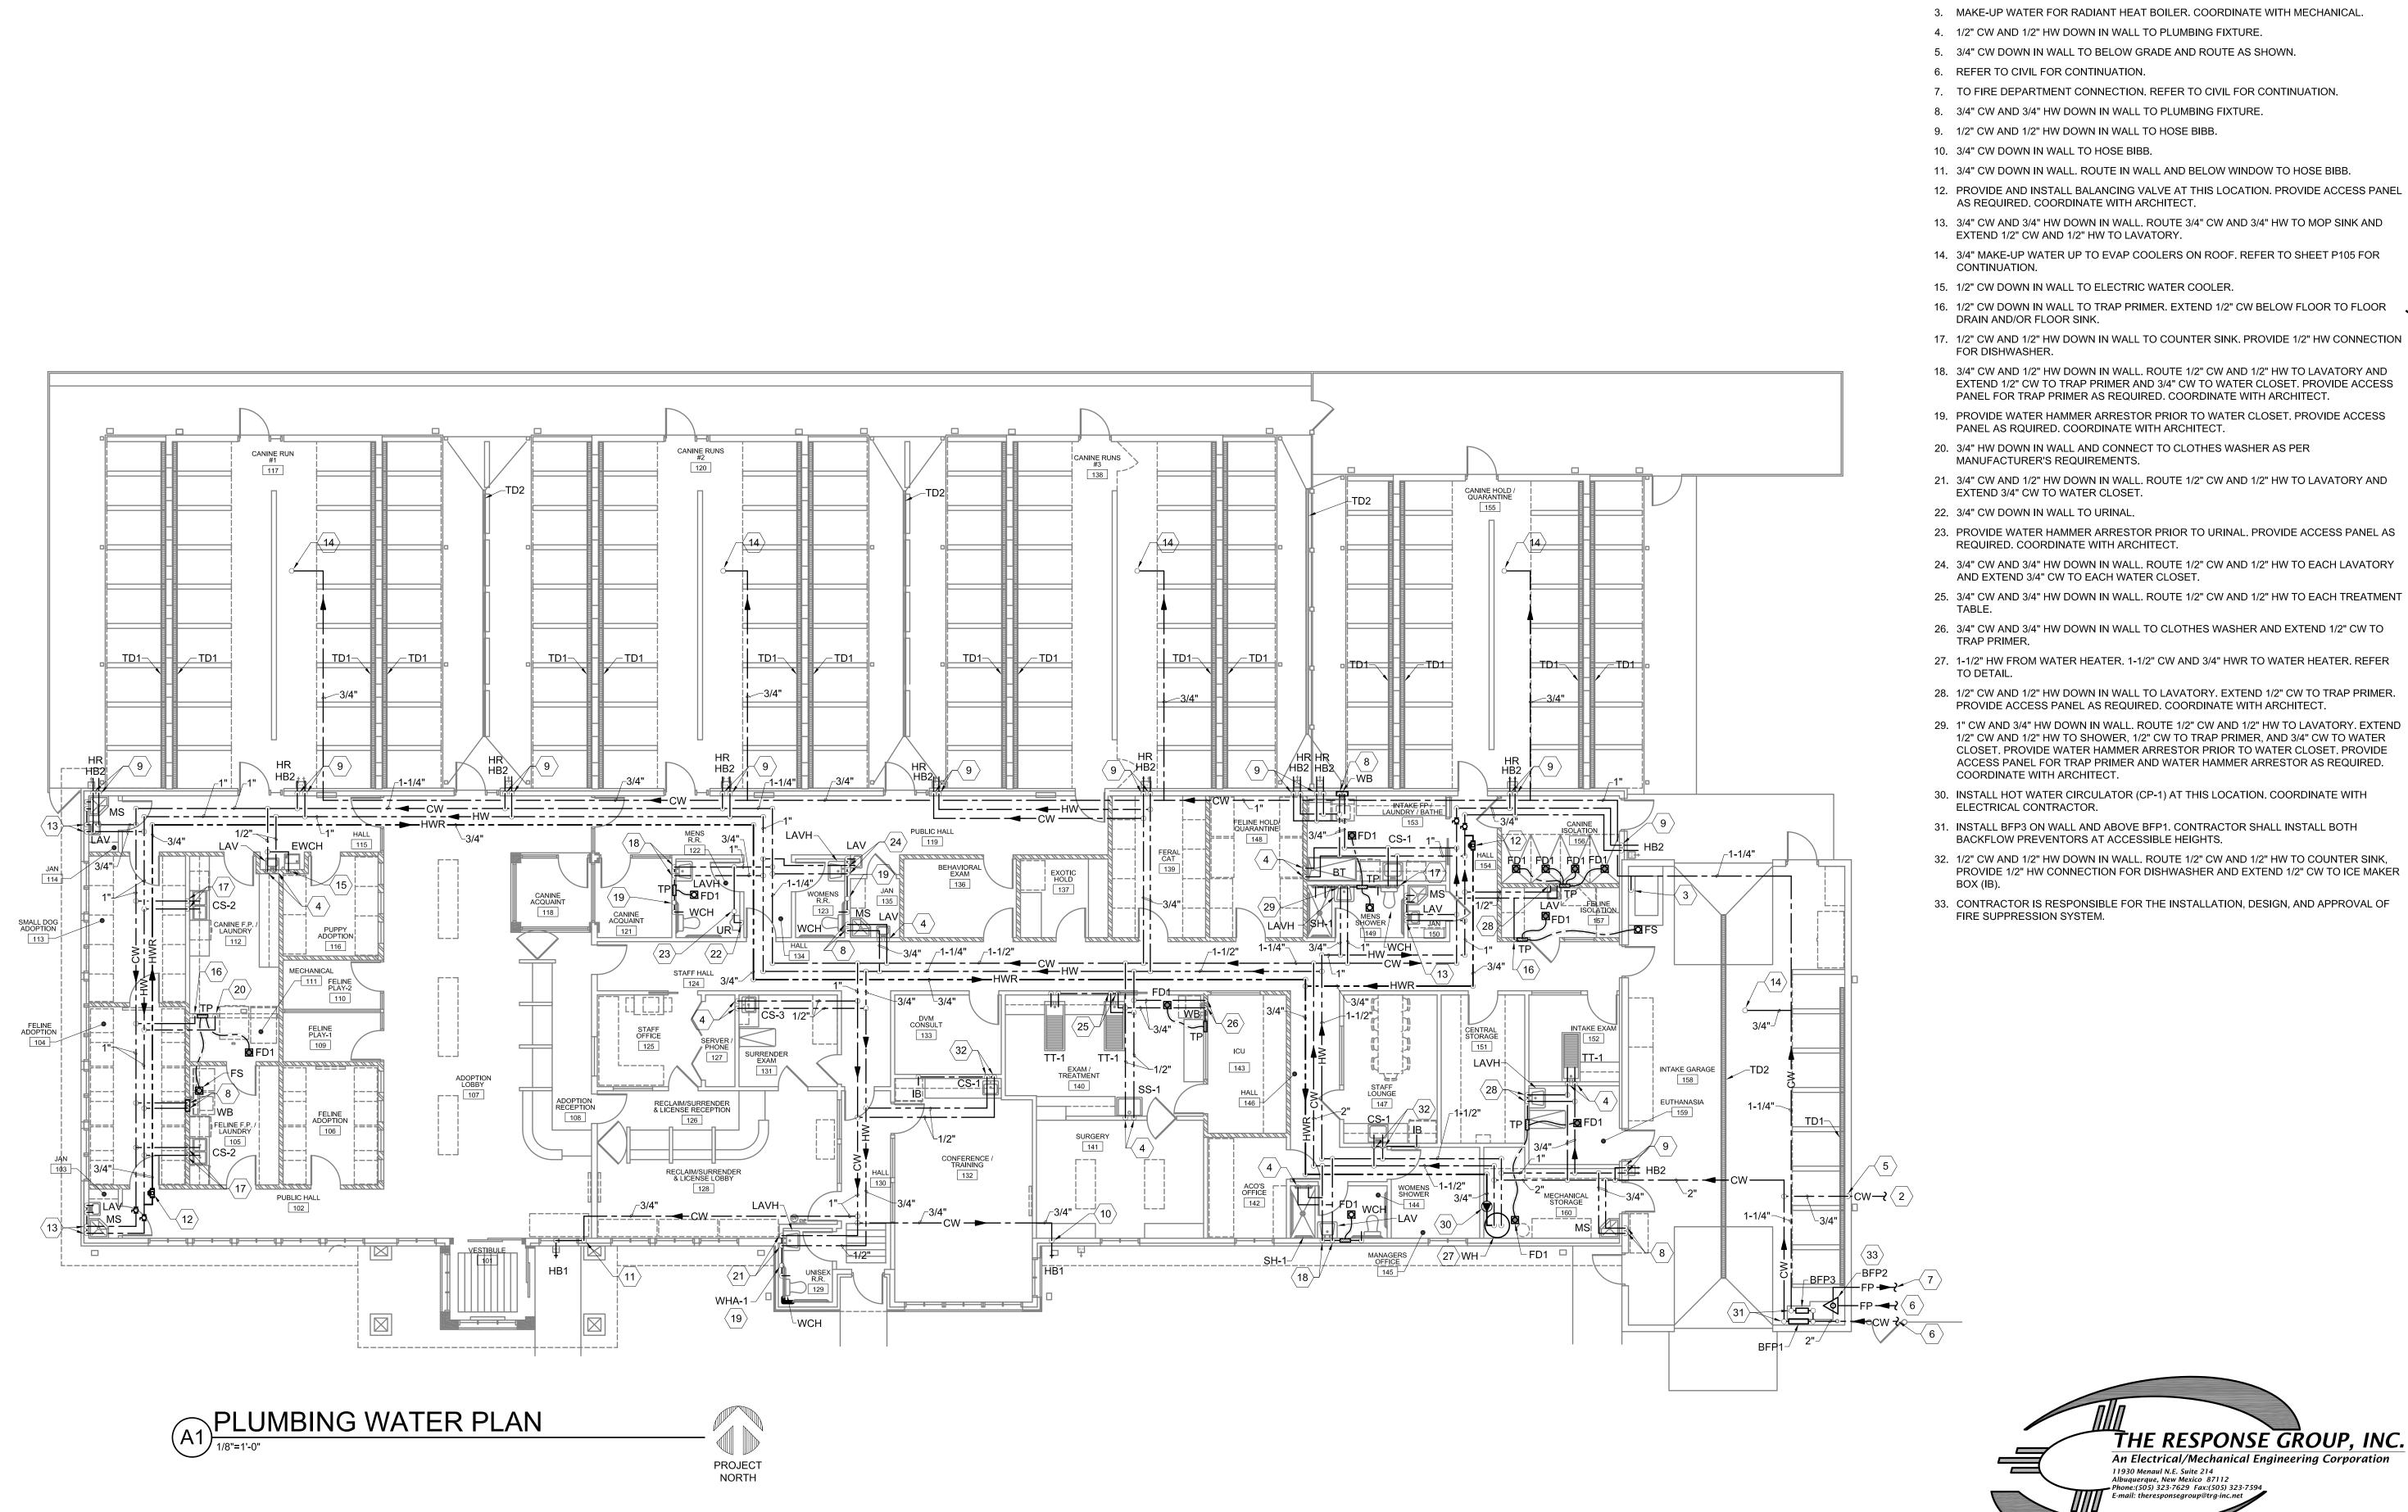

GENERAL NOTES

A. REFER TO PLUMBING SHEET P101 FOR GENERAL NOTES.

KEYED NOTES

- 1. GAS LINE UP TO ROOF TOP UNIT. REFER TO SHEET P105 FOR CONTINUATION.
- 2. 3/4" CW TO YARD HYDRANT. COORDINATE WITH CIVIL AND ARCHITECT FOR LOCATION OF YARD HYDRANT.

- 14. 3/4" MAKE-UP WATER UP TO EVAP COOLERS ON ROOF. REFER TO SHEET P105 FOR
- 18. 3/4" CW AND 1/2" HW DOWN IN WALL. ROUTE 1/2" CW AND 1/2" HW TO LAVATORY AND EXTEND 1/2" CW TO TRAP PRIMER AND 3/4" CW TO WATER CLOSET. PROVIDE ACCESS
- 21. 3/4" CW AND 1/2" HW DOWN IN WALL. ROUTE 1/2" CW AND 1/2" HW TO LAVATORY AND
- 23. PROVIDE WATER HAMMER ARRESTOR PRIOR TO URINAL. PROVIDE ACCESS PANEL AS
- 24. 3/4" CW AND 3/4" HW DOWN IN WALL. ROUTE 1/2" CW AND 1/2" HW TO EACH LAVATORY
- 25. 3/4" CW AND 3/4" HW DOWN IN WALL. ROUTE 1/2" CW AND 1/2" HW TO EACH TREATMENT
- 26. 3/4" CW AND 3/4" HW DOWN IN WALL TO CLOTHES WASHER AND EXTEND 1/2" CW TO
- 28. 1/2" CW AND 1/2" HW DOWN IN WALL TO LAVATORY. EXTEND 1/2" CW TO TRAP PRIMER.
- 29. 1" CW AND 3/4" HW DOWN IN WALL. ROUTE 1/2" CW AND 1/2" HW TO LAVATORY. EXTEND 1/2" CW AND 1/2" HW TO SHOWER, 1/2" CW TO TRAP PRIMER, AND 3/4" CW TO WATER CLOSET. PROVIDE WATER HAMMER ARRESTOR PRIOR TO WATER CLOSET. PROVIDE ACCESS PANEL FOR TRAP PRIMER AND WATER HAMMER ARRESTOR AS REQUIRED.
- 30. INSTALL HOT WATER CIRCULATOR (CP-1) AT THIS LOCATION. COORDINATE WITH
- 32. 1/2" CW AND 1/2" HW DOWN IN WALL. ROUTE 1/2" CW AND 1/2" HW TO COUNTER SINK,
- 33. CONTRACTOR IS RESPONSIBLE FOR THE INSTALLATION, DESIGN, AND APPROVAL OF


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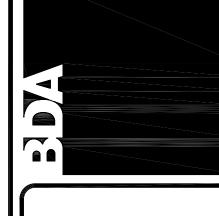
TER WA **PLUMBING**


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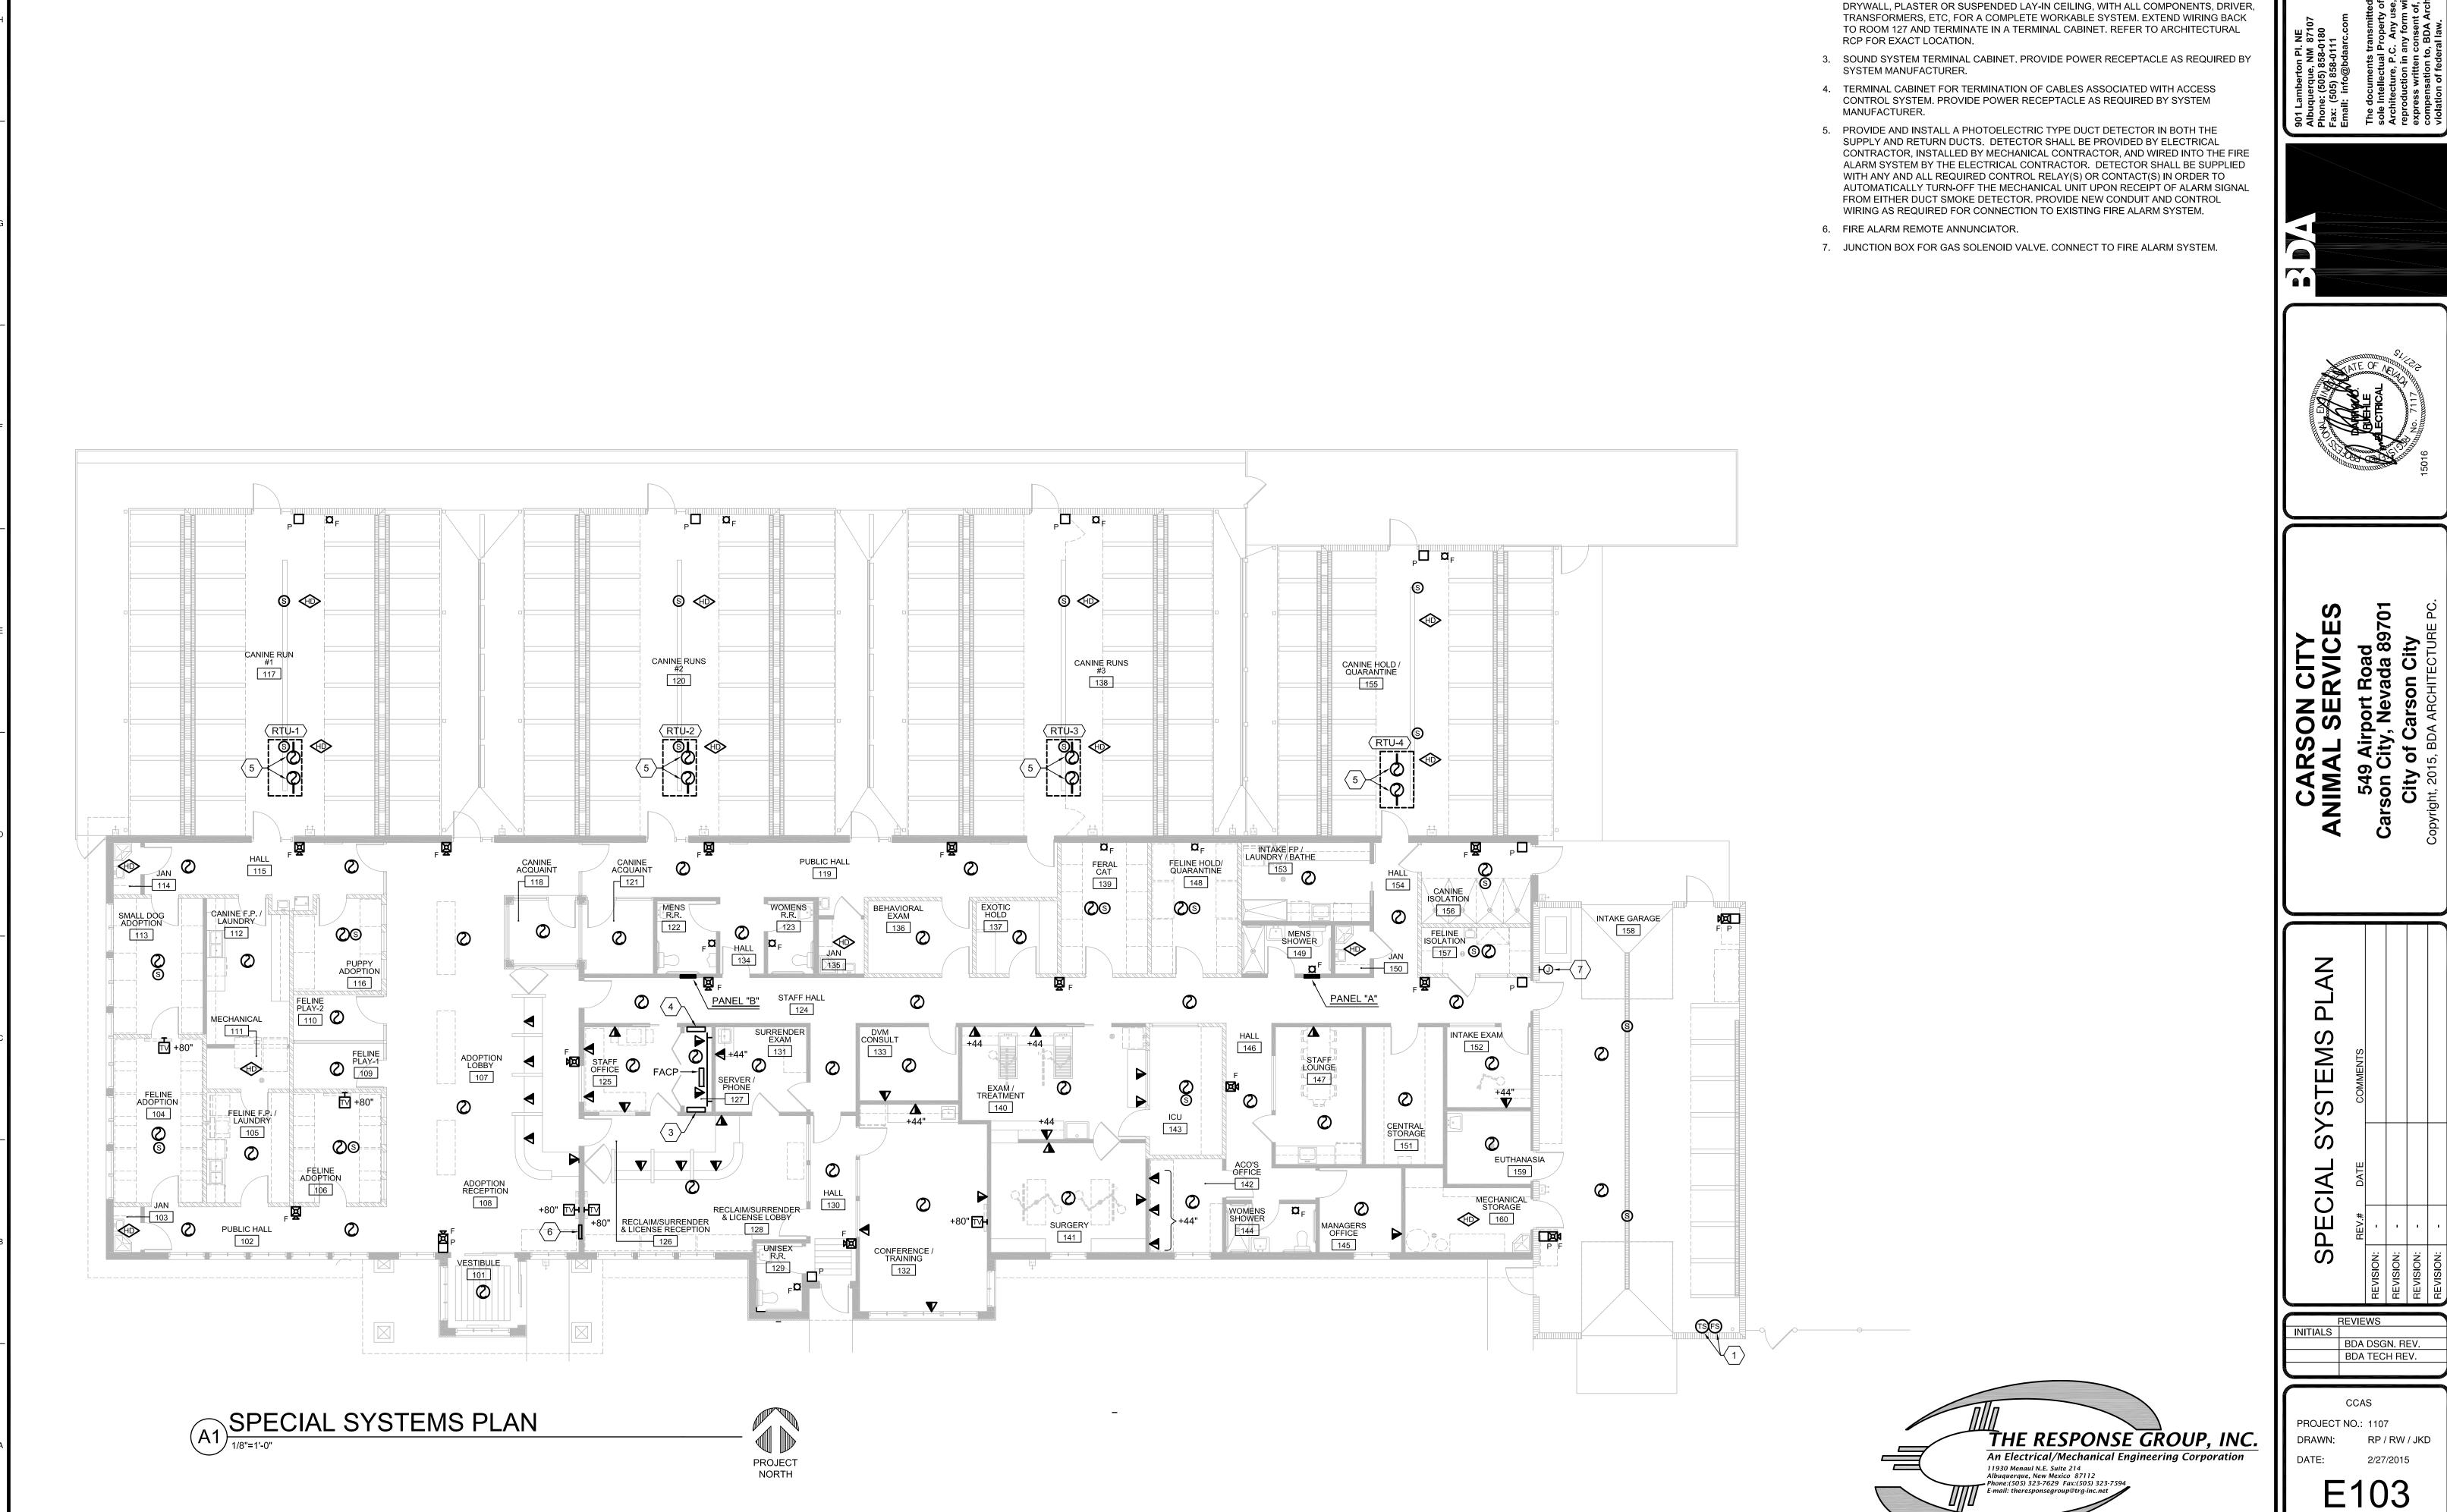
PROJECT NO.: 1107

DRAWN: CMB/TD DATE:





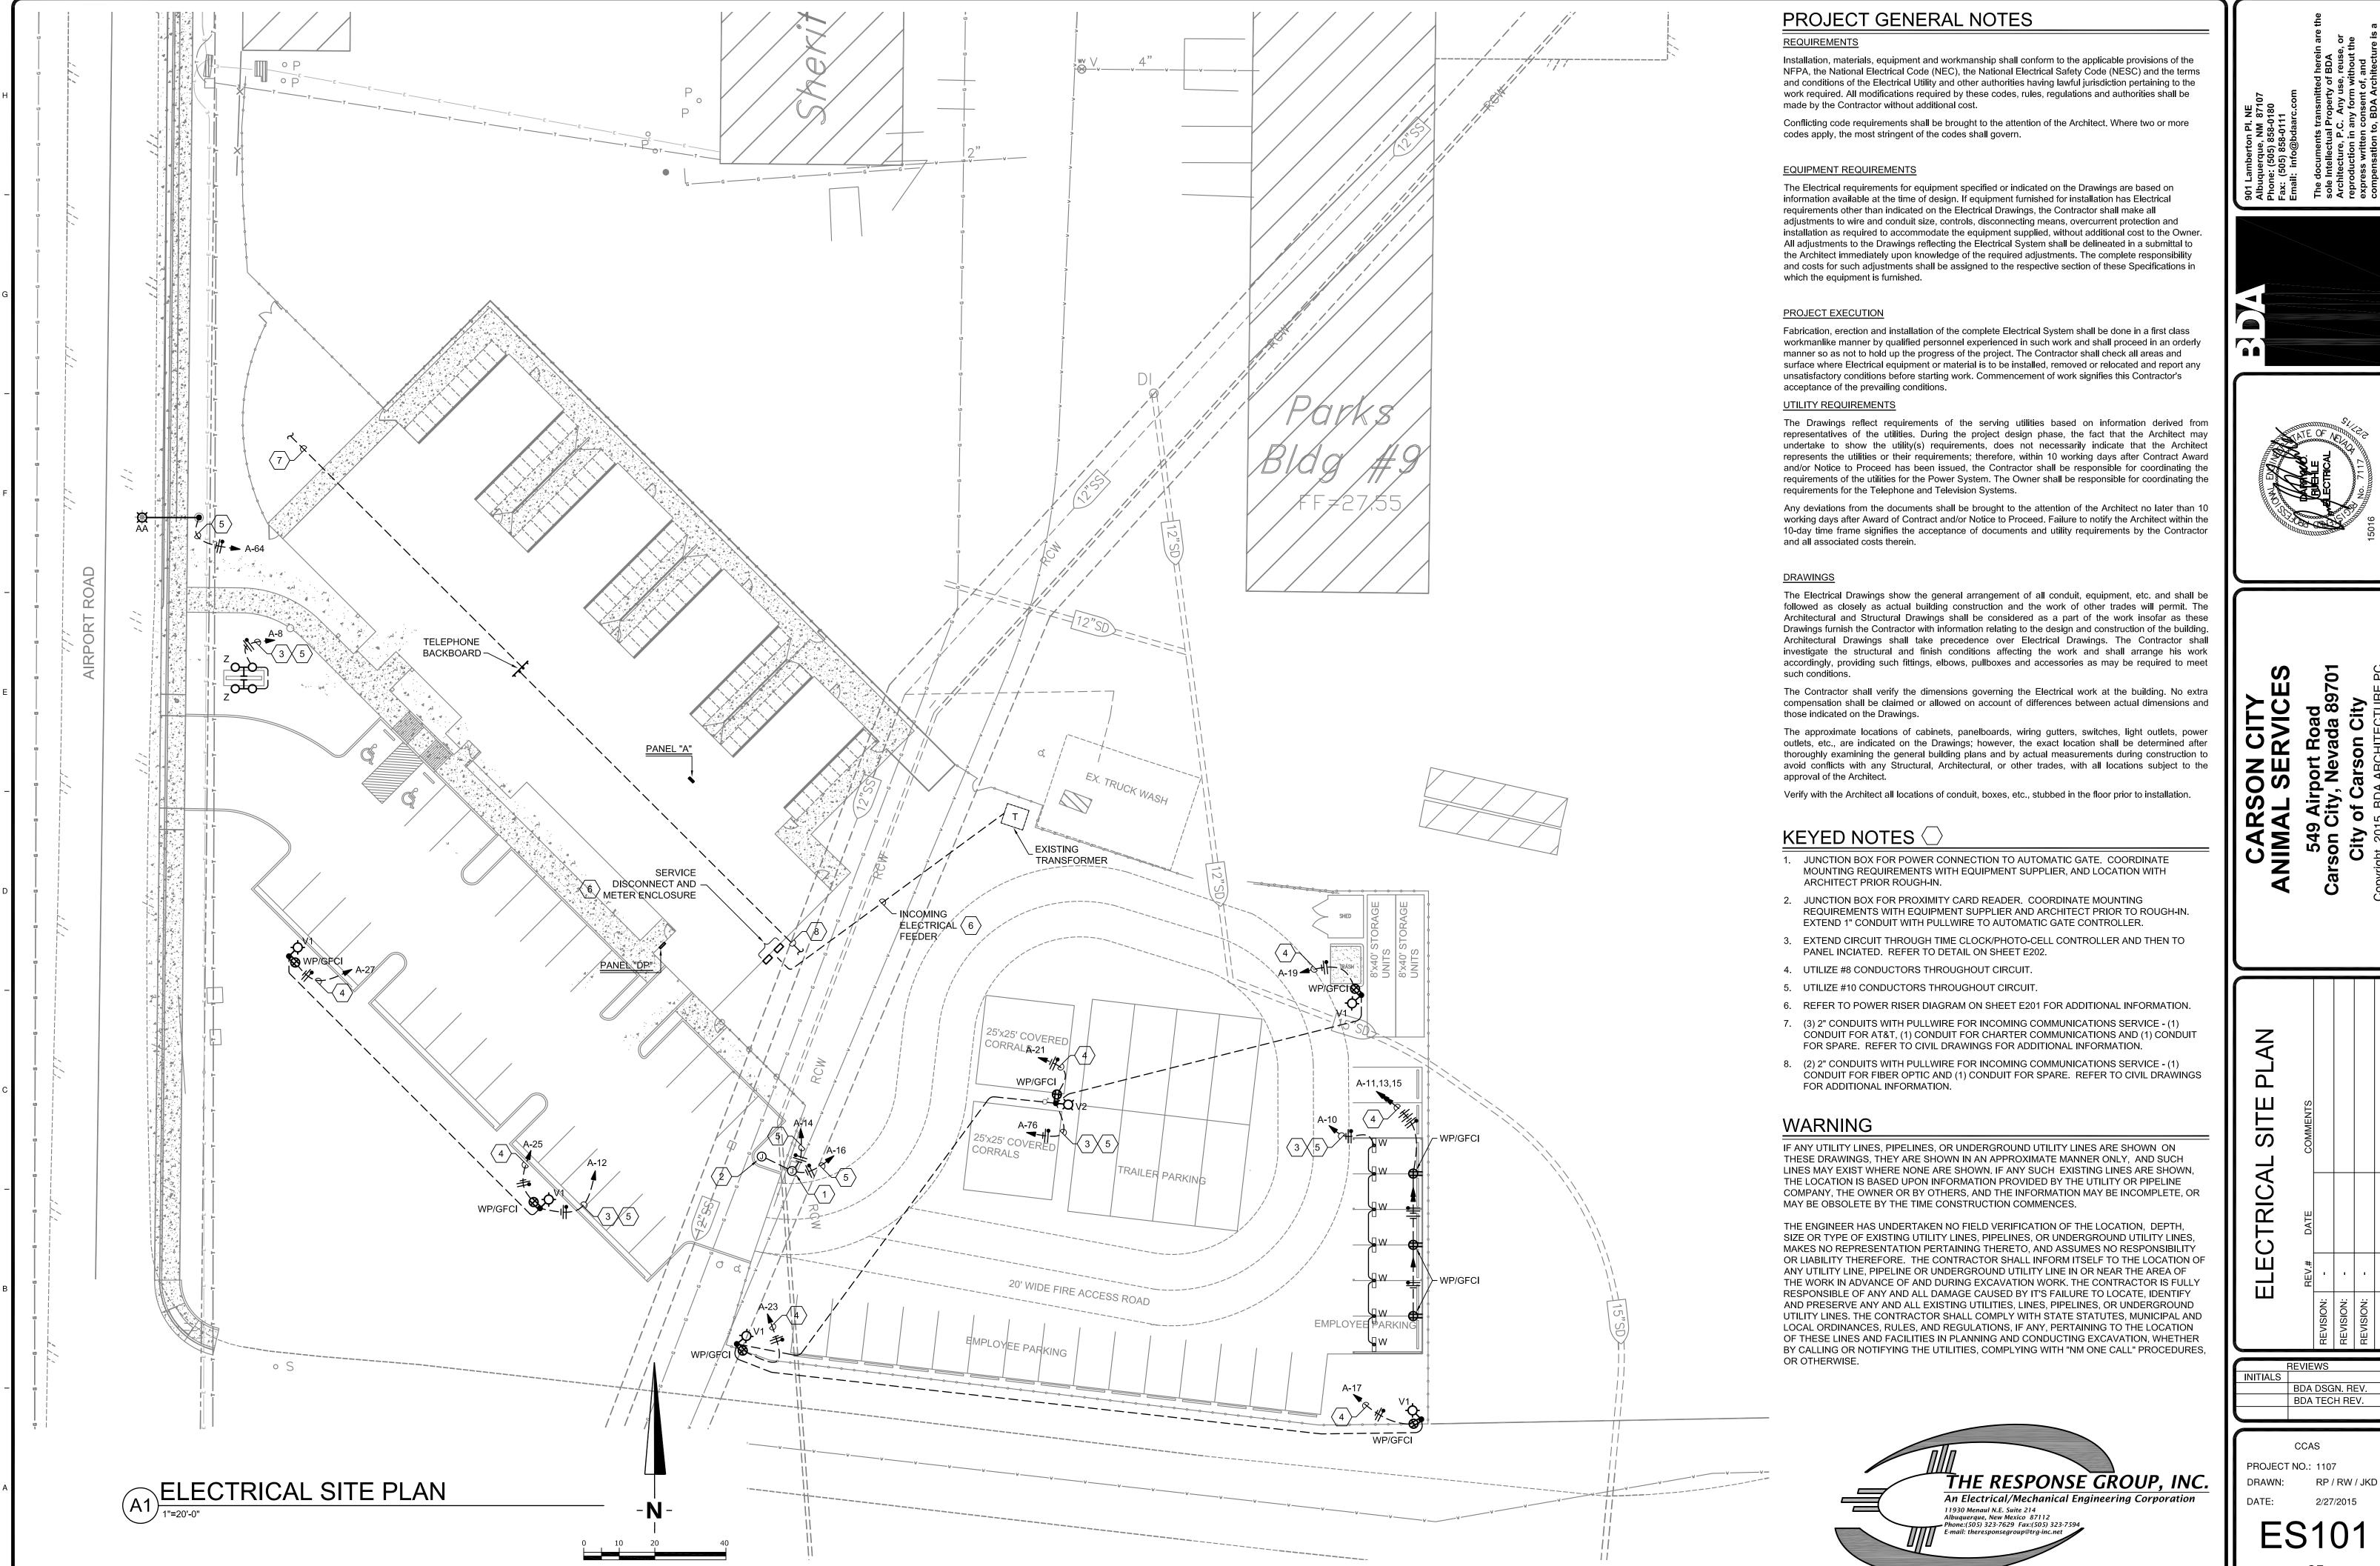

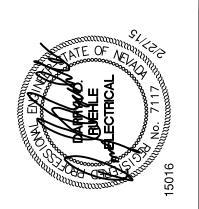


KEYED NOTES

1. CONNECTION OF FIRE ALARM TAMPER AND FLOW SWITCHES TO THE FIRE ALARM SYSTEM, BY OTHERS.


2. FLUSH 8" CEILING MOUNTED SPEAKER WITH BACKBOX CAPABLE OF INSTALLING IN DRYWALL, PLASTER OR SUSPENDED LAY-IN CEILING, WITH ALL COMPONENTS, DRIVER,



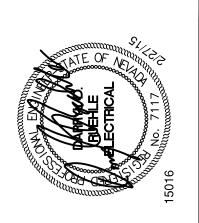

KEYED NOTES \bigcirc

- 1. 240V-60A-3P-4W PLUS SOLID NEUTRAL, FUSIBLE, RAINTIGHT DISCONNECT SWITCH. FUSE AS RECOMMENDED BY UNIT MANUFACTURER. (4) #6 AND (1) #8 GROUND IN 1" CONDUIT.
- 240V-30A-2P-3W PLUS SOLID NEUTRAL, FUSIBLE, RAINTIGHT DISCONNECT SWITCH. FUSE AS RECOMMENDED BY UNIT MANUFACTURER. (3) #10 AND (1) #10 GROUND IN 3/4" CONDUIT.
- 240V-100A-3P-4W PLUS SOLID NEUTRAL, FUSIBLE, RAINTIGHT DISCONNECT SWITCH.
 FUSE AS RECOMMENDED BY UNIT MANUFACTURER. (4) #4 AND (1) #8 GROUND IN 1 1/4"
 CONDUIT.
- 240V-60A-3P-4W PLUS SOLID NEUTRAL, FUSIBLE, RAINTIGHT DISCONNECT SWITCH. FUSE AS RECOMMENDED BY UNIT MANUFACTURER. (4) #8 AND (1) #10 GROUND IN 3/4" CONDUIT.
 240V-30A-2P-3W PLUS SOLID NEUTRAL, FUSIBLE, RAINTIGHT DISCONNECT SWITCH.
- FUSE AS RECOMMENDED BY UNIT MANUFACTURER. (3) #12 AND (1) #12 GROUND IN 3/4" CONDUIT.
- 6. 240V-30A-3P-4W PLUS SOLID NEUTRAL, FUSIBLE, RAINTIGHT DISCONNECT SWITCH. FUSE AS RECOMMENDED BY UNIT MANUFACTURER.
- 7. (4) #10 AND (1) #10 GROUND IN 3/4" CONDUIT.

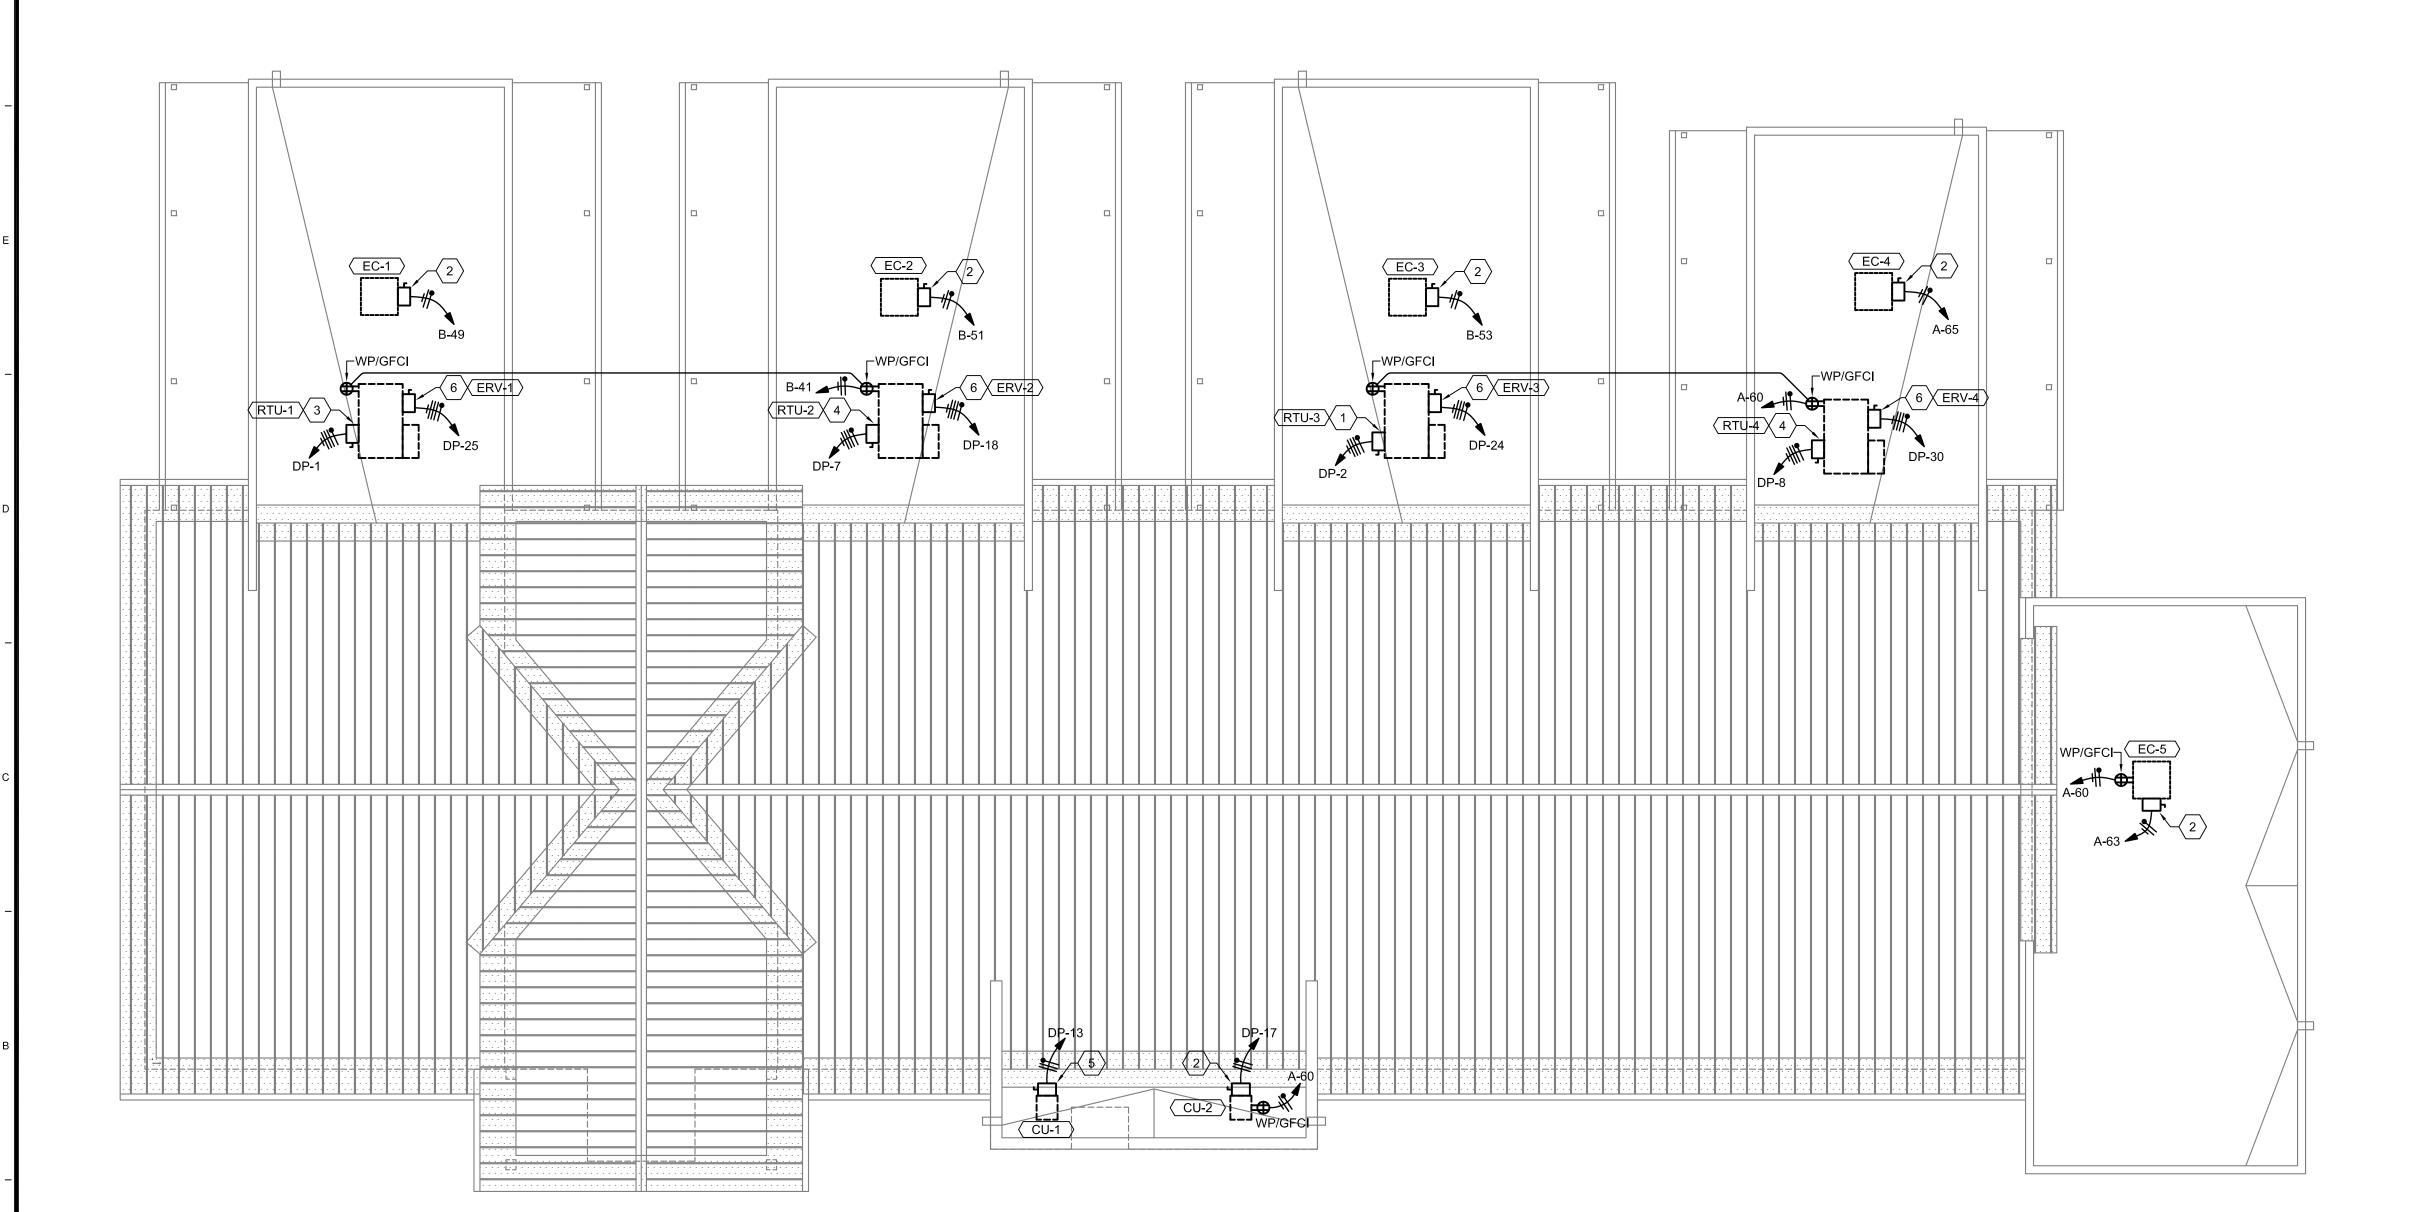

ELECTRICAL ROOF PLAN

1/8"=1'-0"



THE RESPONSE GROUP, INC.


An Electrical/Mechanical Engineering Corporation

11930 Menaul N.E. Suite 214

Albuquerque, New Mexico 87112

Phone:(505) 323-7629 Fax:(505) 323-7594

E-mail: theresponsegroup@trg-inc.net

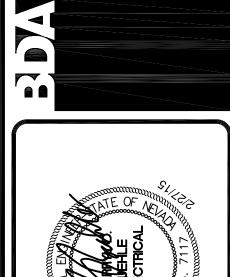

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ANIMAL SERVICES
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Carson City, Nevada 89701
City of Carson City
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L ROOF PLAN

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BDA TECH REV.

CCAS ROJECT NO.: 1107

PROJECT NO.: 1107

DRAWN: RP / RW / J

DATE: 2/27/2015

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